

Site Statistics:		
Gross Site Area:	10,016.56 m²	1.00 ha
Estimated Road Widening:	425.14 m <sup>2</sup>	0.04 ha
Estimated Net Site Area:	9,591.42 m²	0.96 ha
Lot Frontage:	83.2 m	

Development Statistics:		
<b>Estimated Number of Apartment Units:</b> @ 70m <sup>2</sup> /unit:	334	
Building Height: 1	0-Storeys 31.5m	
Density: 3	47.9 units/net ha	
Building Area:	3,812 m²	
Building Coverage:	(3,812 m²) 39.7%	
Landscaped Open Space: <sup>*</sup>	5,023 m²	52.4%
Landscaped area calculation includes walkways, patios, raised planters, emegency access with pavers, and sodder	d areas.	
Common Outdoor Amenity:	1,465 m²	15.3%
Total Estimated GCA:	29,565 m²	
Office/Commercial (FI 1):	588 m <sup>2</sup>	
Residential FI (1-10):	28,977 m²	
Total Estimated GFA (95% GCA):	28,087 m²	
Office/Commercial (FI 1):	559 m²	
Residential FI (1-10):	27,528 m²	
Floor Space Index (FSI):		
Gross FSI:	2.80	
Net FSI:	2.93	
Parking Rates Used:	178 sp	
Office/Commercial @ 1 sp/50m² GFA:	11 sp	
Residential @ 0.5 sp/unit (includes visitor pl	<): 167 sp	
Parking Spaces Provided:	178 sp	
Surface:	9 sp	
Underground (Estimated 1.3 levels):**	169 sp	
*Based on an area of 5,448 m² (1.35 acres) and a rate of 100 sp/acre.		
Barrier-free Parking: Required @ 1 sp+3% of spaces between 10	01-200 sp 7 <b>sp</b>	
Barrier-free Parking Provided:	7 sp	
At grade:	2 sp	
Underground:	5 sp	
Bike Parking Required:	339 sp	
Residential Short-Term @ 0.1 sp/unit:	33 sp	
Residential Long-Term @ 0.9 sp/unit:	301 sp	
Commercial/Office @ 3 sp+0.3 sp/100m <sup>2</sup> of 0	GFA: 5 sp	
Bike Parking Provided:	339 sp	
Outdoor Commercial:	5 sp	
Outdoor Residential (Short-term):	33 sp	
Indoor and Underground Residential (Long-	term) : 301 sp	
Proposed Green Roof:	936 m²	

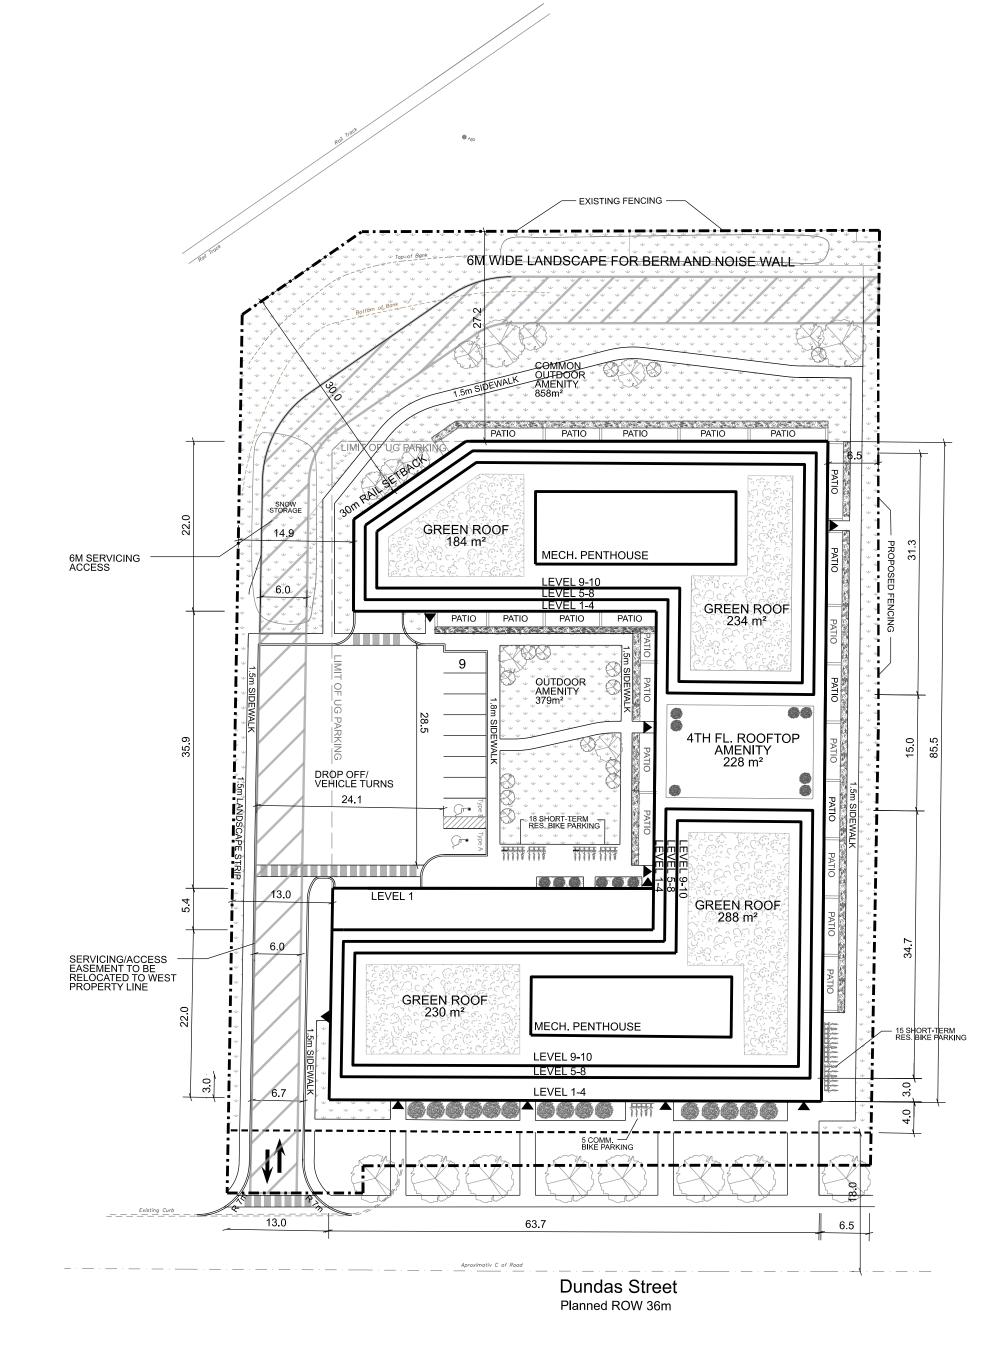

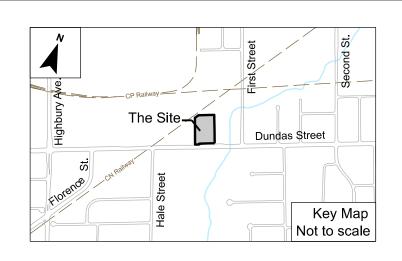

#### LEGEND

	Site Boundary
	Future Street Line
	Relocated Access/Servicing Easements
· · ·	Landscaped Area
	Building Area
0.00	Green Roof
	Planter
	Proposed Conceptual Trees
	Proposed Conceptual Shrubs
	Building Entrance/Exit


#### Notes:


- Property Boundary based on survey prepared by Young & Young Surveying Inc. dated December 2021.
  Not based on engineering, floodplain or
- grading analysis. Road widening estimated and subject to review.
- Assuming relocation of access and servicing
- easements on site.
- Areas and dimensions are approximate.
- GFA and unit counts are estimated and subject to change based on detailed design.
- Underground parking subject to change based on detailed design.
- Typical parking space dimension 2.7m x 5.5m, and drive aisle 6.7m


DRAWN / REVISED

DRAWN/REVISED	
31 JAN 2024	Minor revisions to landscaped araes
08 NOV 2023	Revised as per discussion w/ client
15 JUN 2023	Revised bike + parking rates+minor site plan modifications
01 JUN 2023	Revised parking rates
03 NOV 2022	Adjusted with revised loading
30 AUG 2022	Issued for Coordination
07 FEB 2022	Issued for PAC
07 JAN 2022	First Draft

## SITE CONCEPT PLAN 1472 DUNDAS STREET CITY OF LONDON

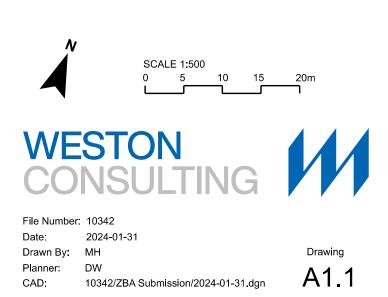

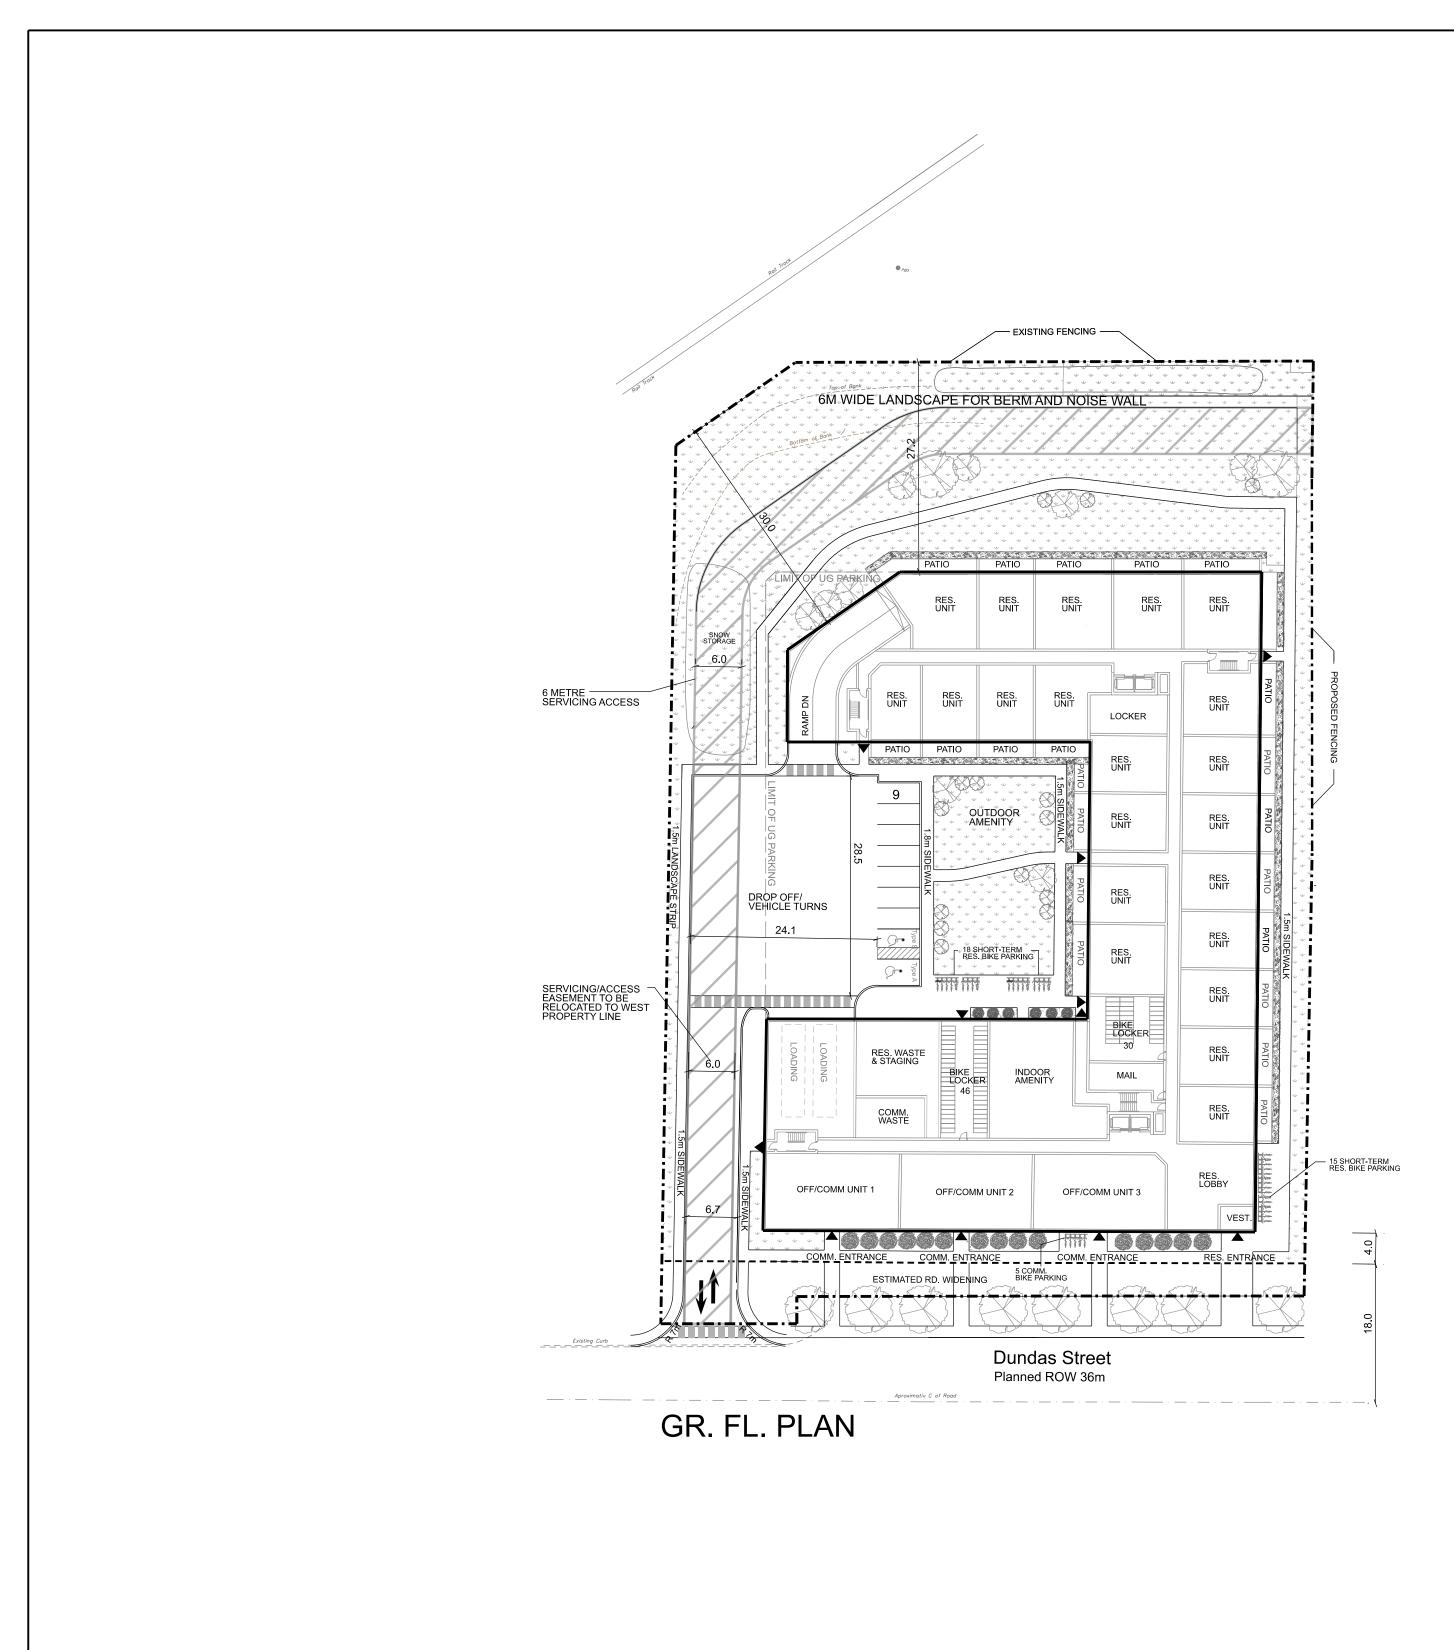

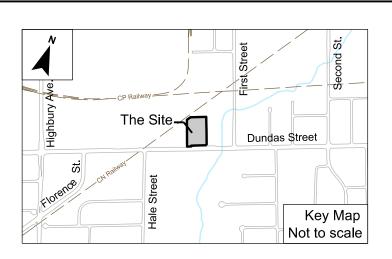

#### LEGEND

<b>—·</b> —	Site Boundary
	Future Street Line
	Relocated Access/Servicing Easements
· · · ·	Landscaped Area
	Building Area
	Green Roof
	Planter
	Proposed Conceptual Trees
	Proposed Conceptual Shrubs
	Building Entrance/Exit

#### Notes:


- Property Boundary based on survey prepared by
- Young & Young Surveying Inc. dated December 2021. - Not based on engineering, floodplain or
- grading analysis.
- Road widening estimated and subject to review. - Assuming relocation of access and servicing
- easements on site
- Areas and dimensions are approximate.
- GFA and unit counts are estimated and subject to change based on detailed design.
- Underground parking subject to change based on detailed design.
- Typical parking space dimension 2.7m x 5.5m, and drive aisle 6.7m

#### DRAWN / REVISED


CAD:


31 JAN 2024	Minor revisions to landscaped araes
08 NOV 2023	Revised as per discussion w/ client
27 SEP 2023	Marked-up for discussion
15 JUN 2023	Adjusted with revised Site Plan
03 NOV 2022	Adjusted with revised loading
30 AUG 2022	Issued for Coordination
07 FEB 2022	Issued for PAC
07 JAN 2022	First Draft

GROUND FLOOR PLAN 1472 DUNDAS STREET CITY OF LONDON

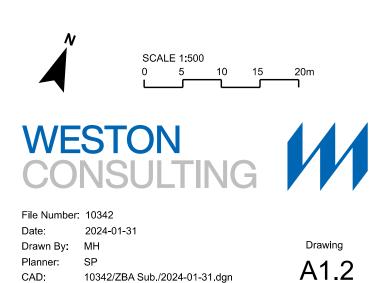


10342/ZBA Sub./2024-01-31.dgn

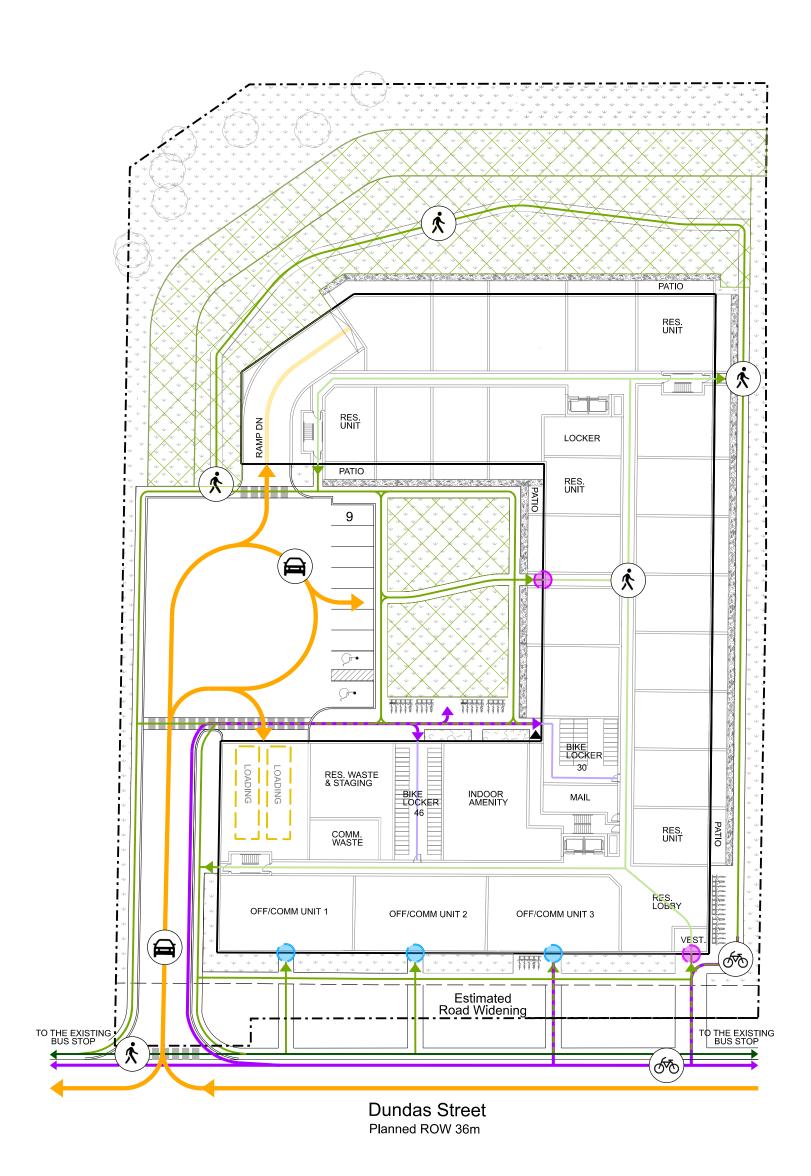

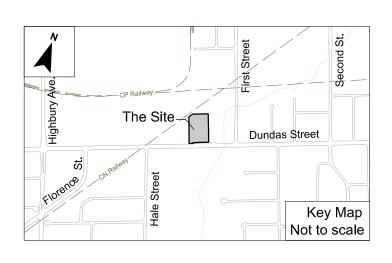

#### LEGEND

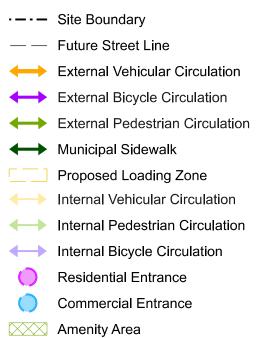


#### Notes:


- Property Boundary based on survey prepared by Young & Young Surveying Inc. dated December 2021.
- Not based on engineering, floodplain or grading analysis.
- Road widening estimated and subject to review.
- Areas and dimensions are approximate.

DRAWN / REVISED


31 JAN 2024	Issued for Revision

### CIRCULATION PLAN 1472 DUNDAS STREET CITY OF LONDON COUNTY OF MIDDLESEX

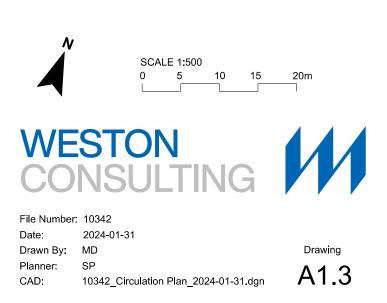

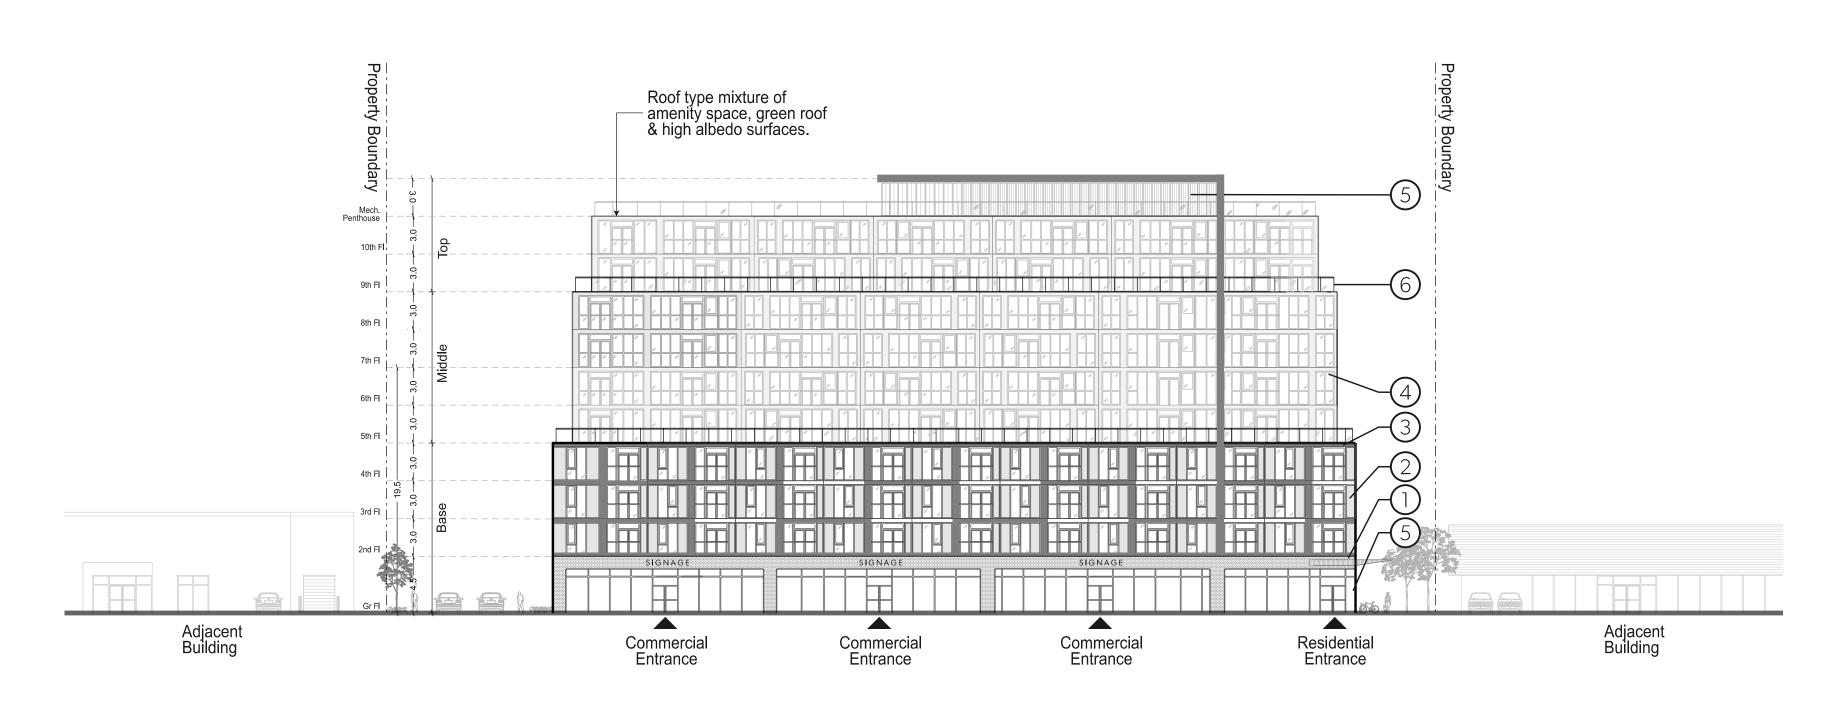


#### MATERIAL PALETTE

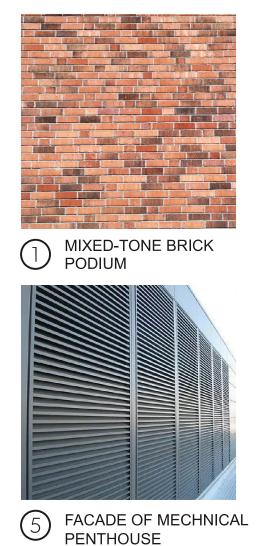




2 ALUMINIUM PANELS FLOORS 2 - 10



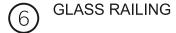





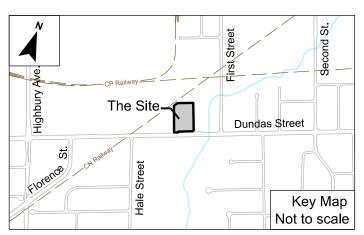





STOREFRONT WINDOWS GROUND FLOOR COMMERCIAL


#### NOTES:

Elevation is conceptual for discussion purposes.
 Materials are preliminary suggestions and subject to change based on detailed design.

#### DRAWN / REVISED

31 JAN 2023	Revised as per City's comments
11 OCT 2022	Issued for ZBA
23 MAR 2022	Issued for PAC




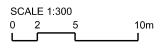




File Number:10342Date:2024-01-31Drawn By:MHPlanner:DWCAD:10342/ZBA Submission/Elevations<br/>/\_Dundas Elevation\_2024-01-31.dgn


Drawing

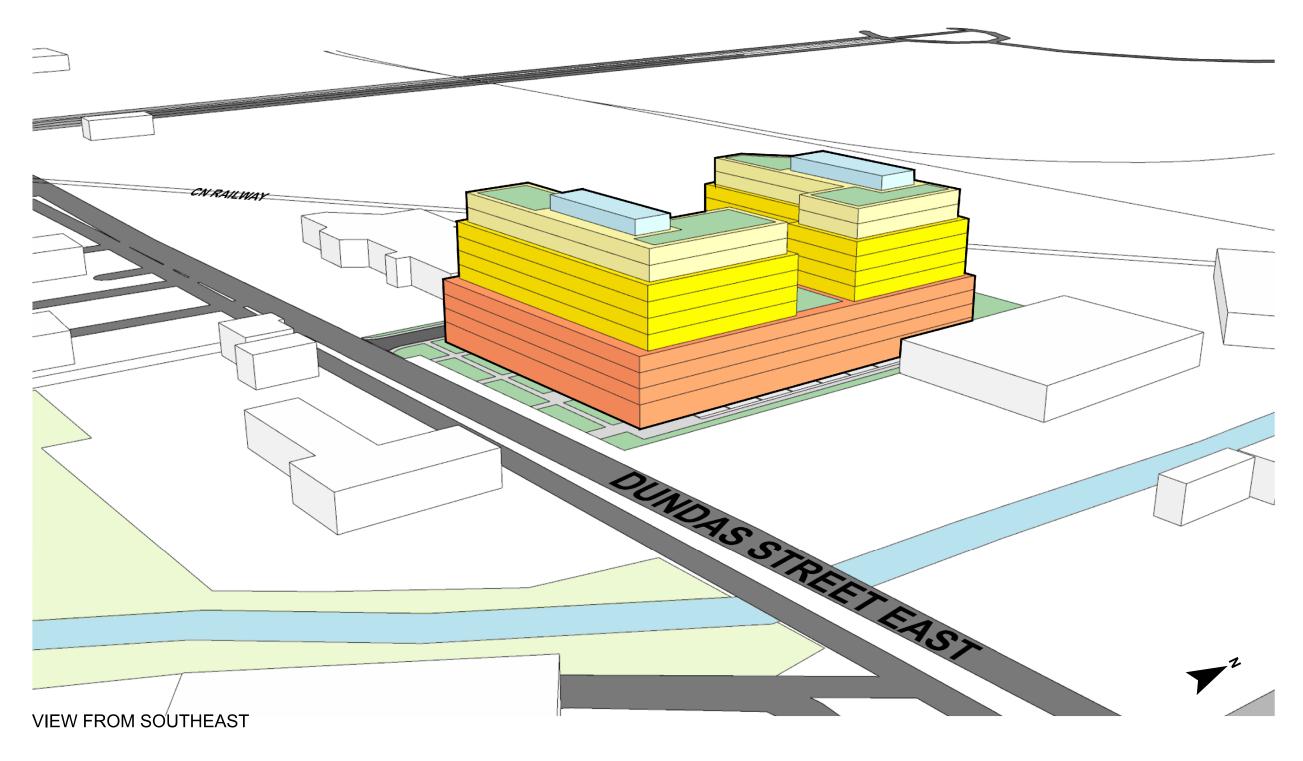

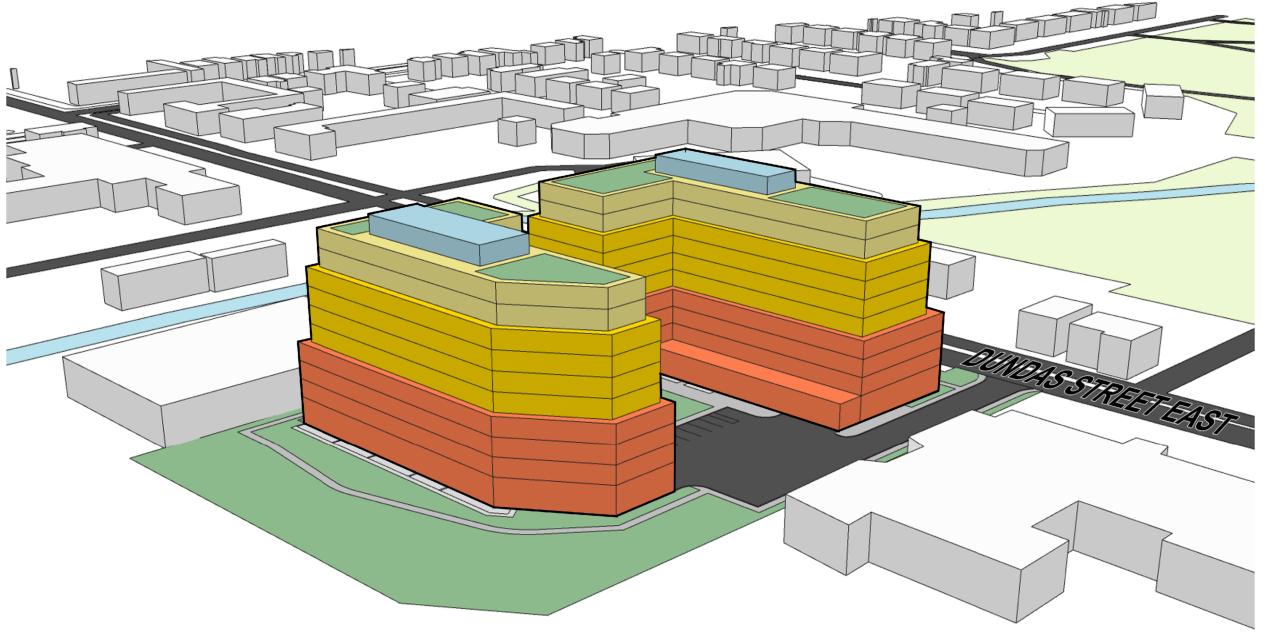

CN RAILWAY

VIEW FROM NORTHWEST

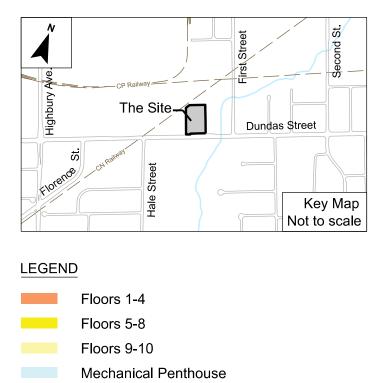

Landscaping, Green Roofs, & Amenity Areas

#### DRAWN / REVISED

31 JAN 2024	First Draft


## **3D MASSING** 1472 DUNDAS STREET CITY OF LONDON

SCALE: N.T.S.



File Number:10342Date:2024-01-31Drawn By:NDCPlanner:SPCAD:10342/SCHEDULES/ZBA/\_2024-01-31.dgn



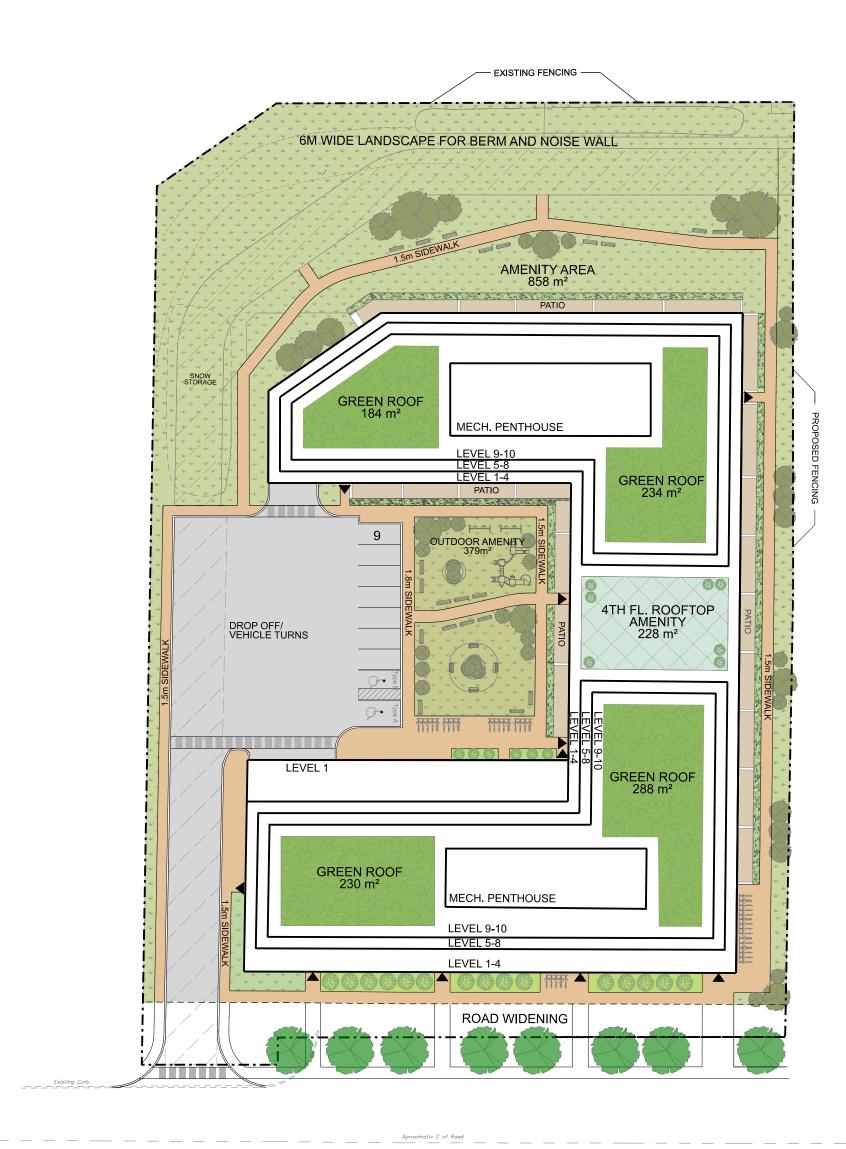

Dundas Street Planned ROW 36m

## N ы 4 The Site ----Dundas Street ŭ Key Map Not to scale

#### LEGEND

	Site Boundary
	Future Street Line
	Relocated Access/Service Easements
· • •	Landscaped Area
	Building Area
	Green Roof
	Planter
	Proposed Conceptual Trees
000	Proposed Conceptual Shrubs
	Building Entrance/Exit
	Walkway
	Paved Area
$[\times\times]$	Rooftop Amenity
	Patio
	Street Trees

#### Notes:

- Property Boundary based on survey prepared by Young & Young Surveying Inc. dated December 2021.
  Not based on engineering, floodplain or
- grading analysis.
- Road widening estimated and subject to review.
- Areas and dimensions are approximate.

DRAWN / REVISED

31 JAN 2024	Issued for Revision

# LANDSCAPE PLAN 1472 DUNDAS STREET CITY OF LONDON COUNTY OF MIDDLESEX

