



MATERIAL LEGEND


- (1) ASPHALT SHINGLES (2) PREFINISHED ROOF VENT
- 3 PREFINISHED ALUMINUM EAVESTROUGH, FASCIA AND
- 6" PREFINISHED WINDOW BATTEN
- 2" PREFINISHED ENHANCED END BATTEN
- PREFINISHED 6" ALUMINUM FRIEZE BOARD
- BRICK VENEER
 PREFINISHED VERTICAL OR HORIZONTAL SIDING (AS
 SHOWN)
- 10 PREFINISHED HORIZONTAL WOOD GRAIN SIDING
- (1) ALUMINUM CLAD PORCH BEAM
- (12) 42" HIGH RAILING/GUARD 'REGAL'
- 🛈 PRECAST CONCRETE STEPS
- PRECAST CONCRETE SILL/HEADER
- (15) (16) FINISHED GRADE
- (17) CONCRETE FOUNDATION
- 18 CONCRETE FOOTING
- GALVANIZED METAL WINDOW WELL (AS REQUIRED)
- 2 1 1/2"x3/4" BREAK IN ALUMINUM FASCIA

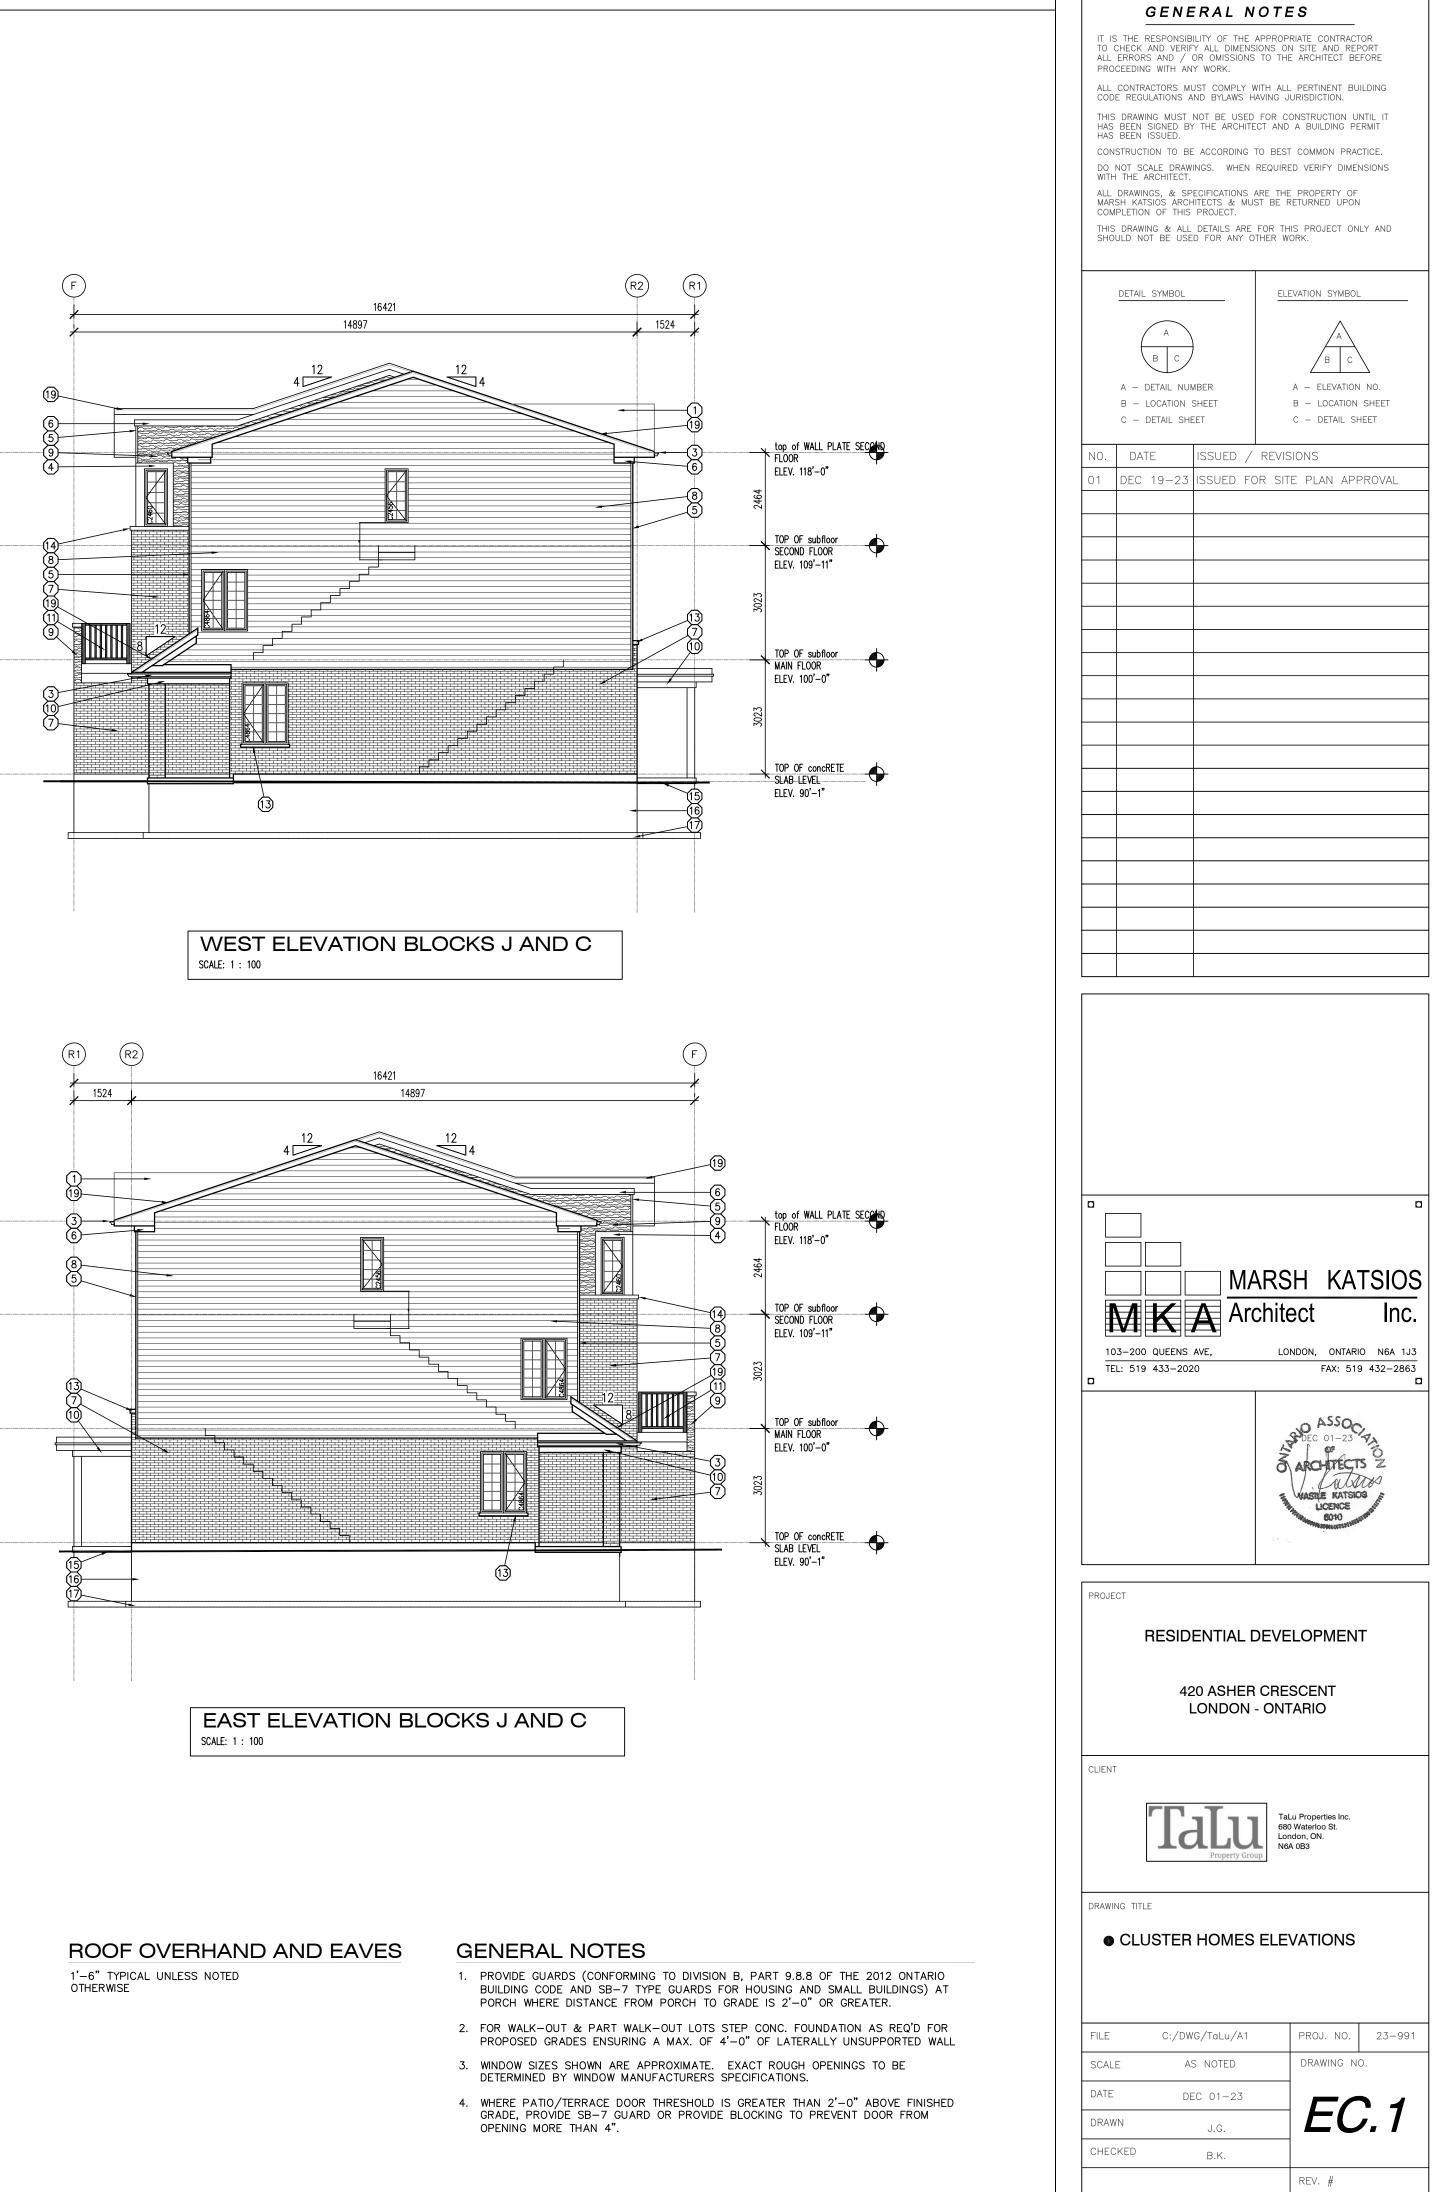

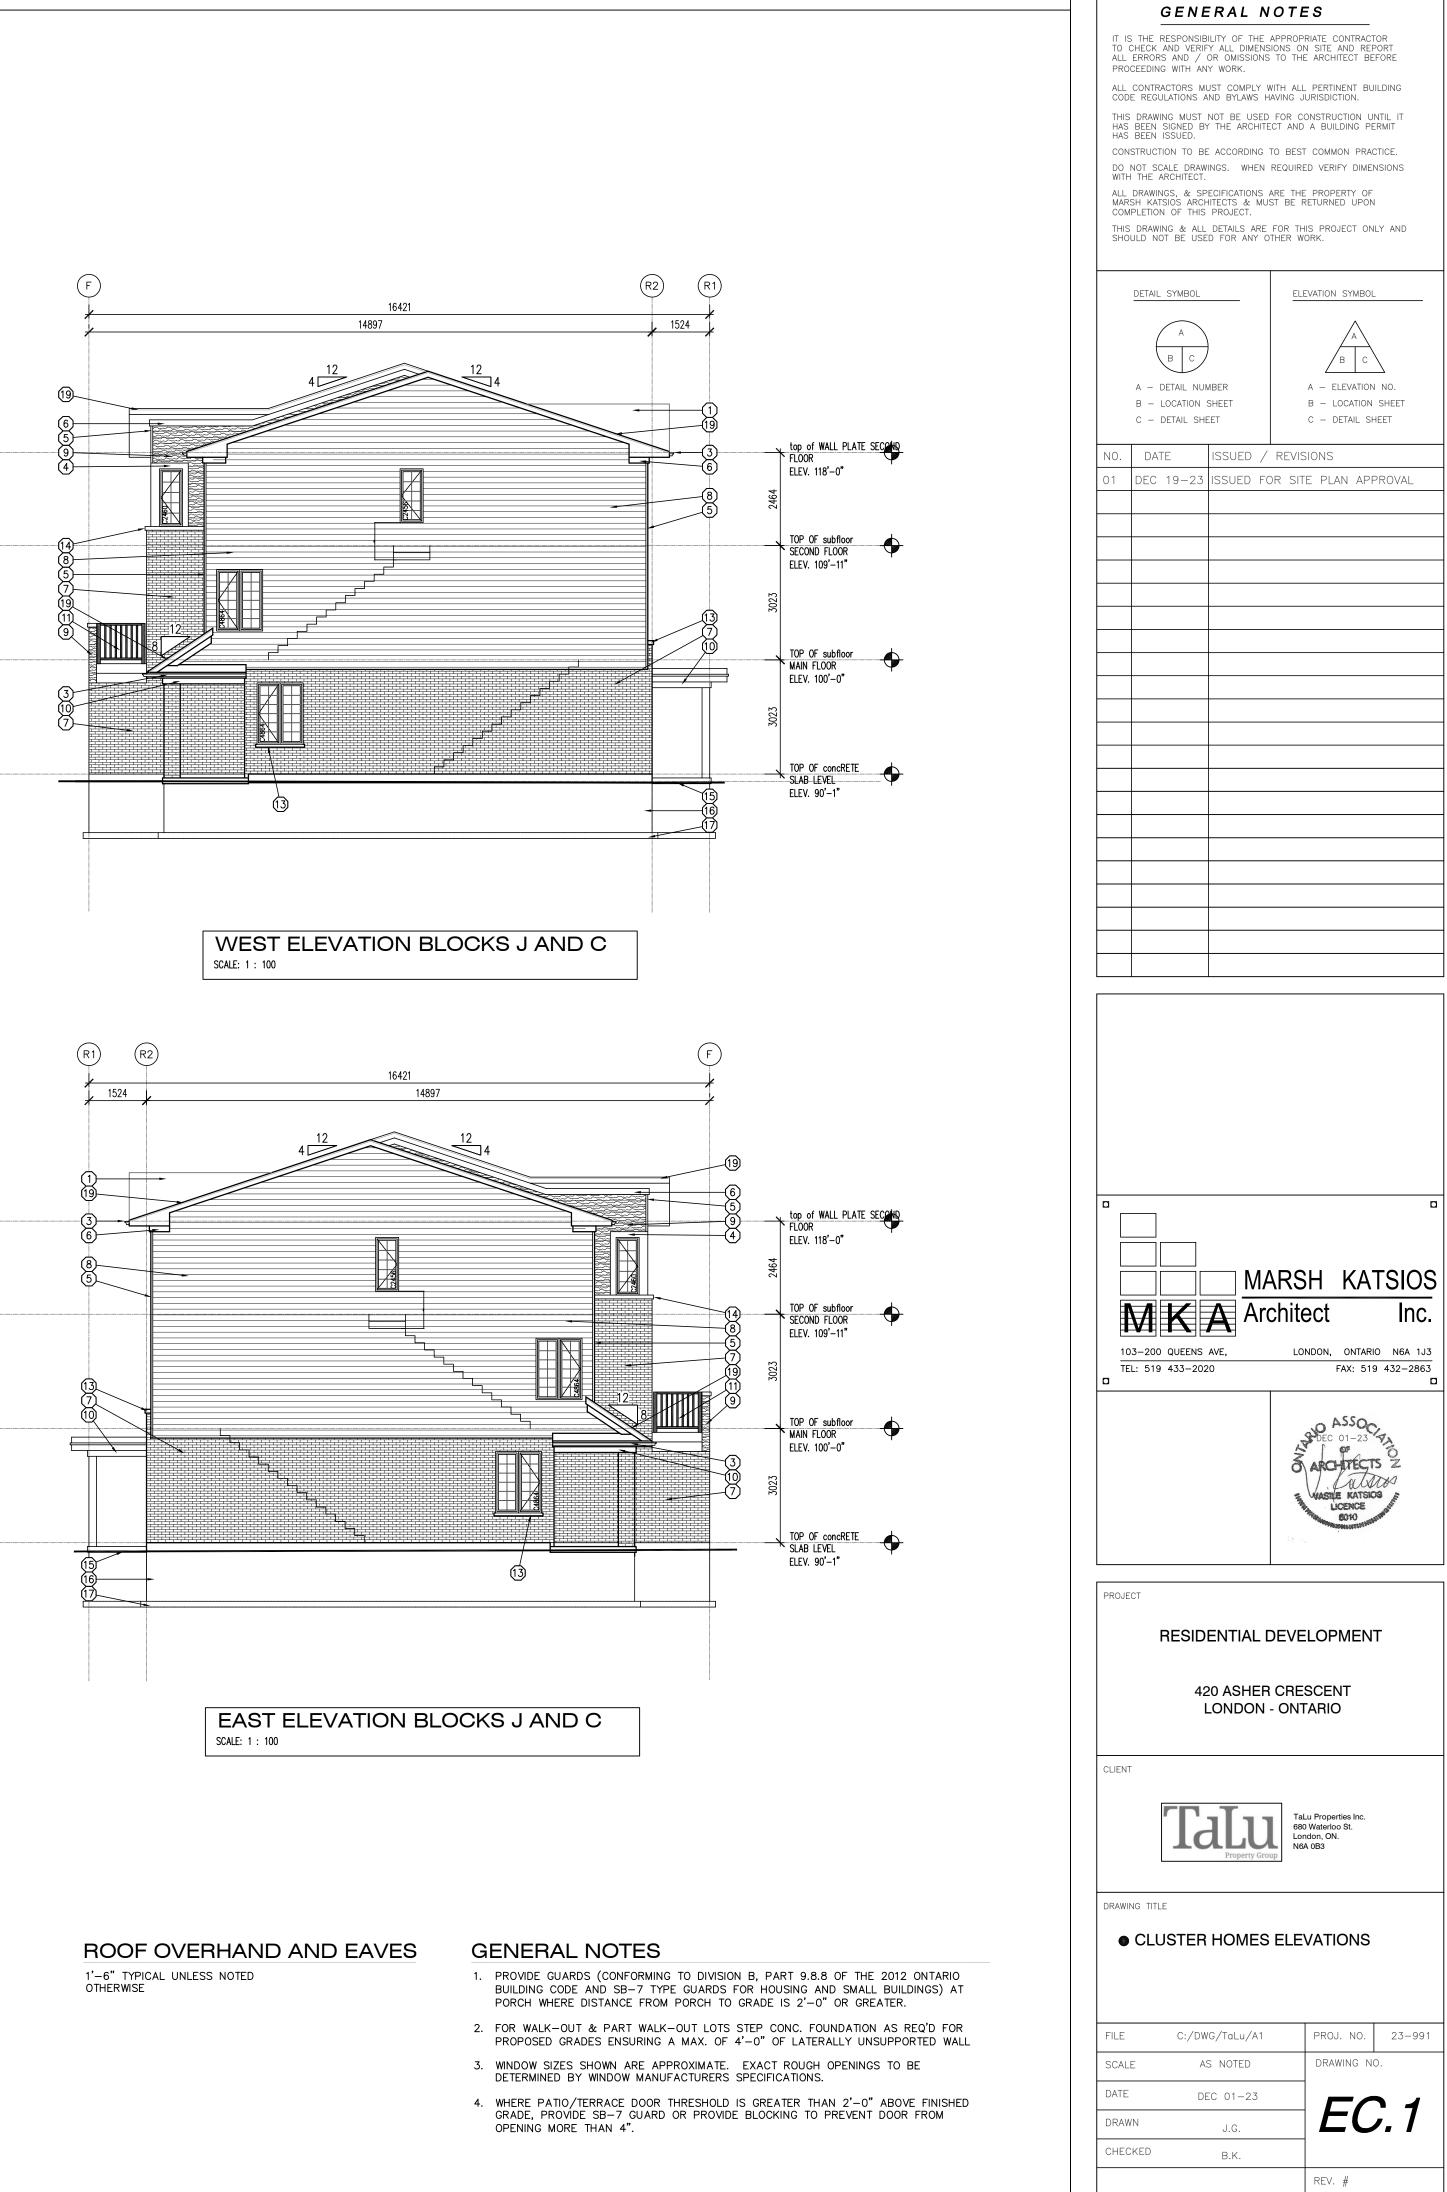


(2) 8X8 ALUMINUM CLAD WOOD POST (2) PRESSURE TREATED DECK PRIVACY FENCE

PRINTED

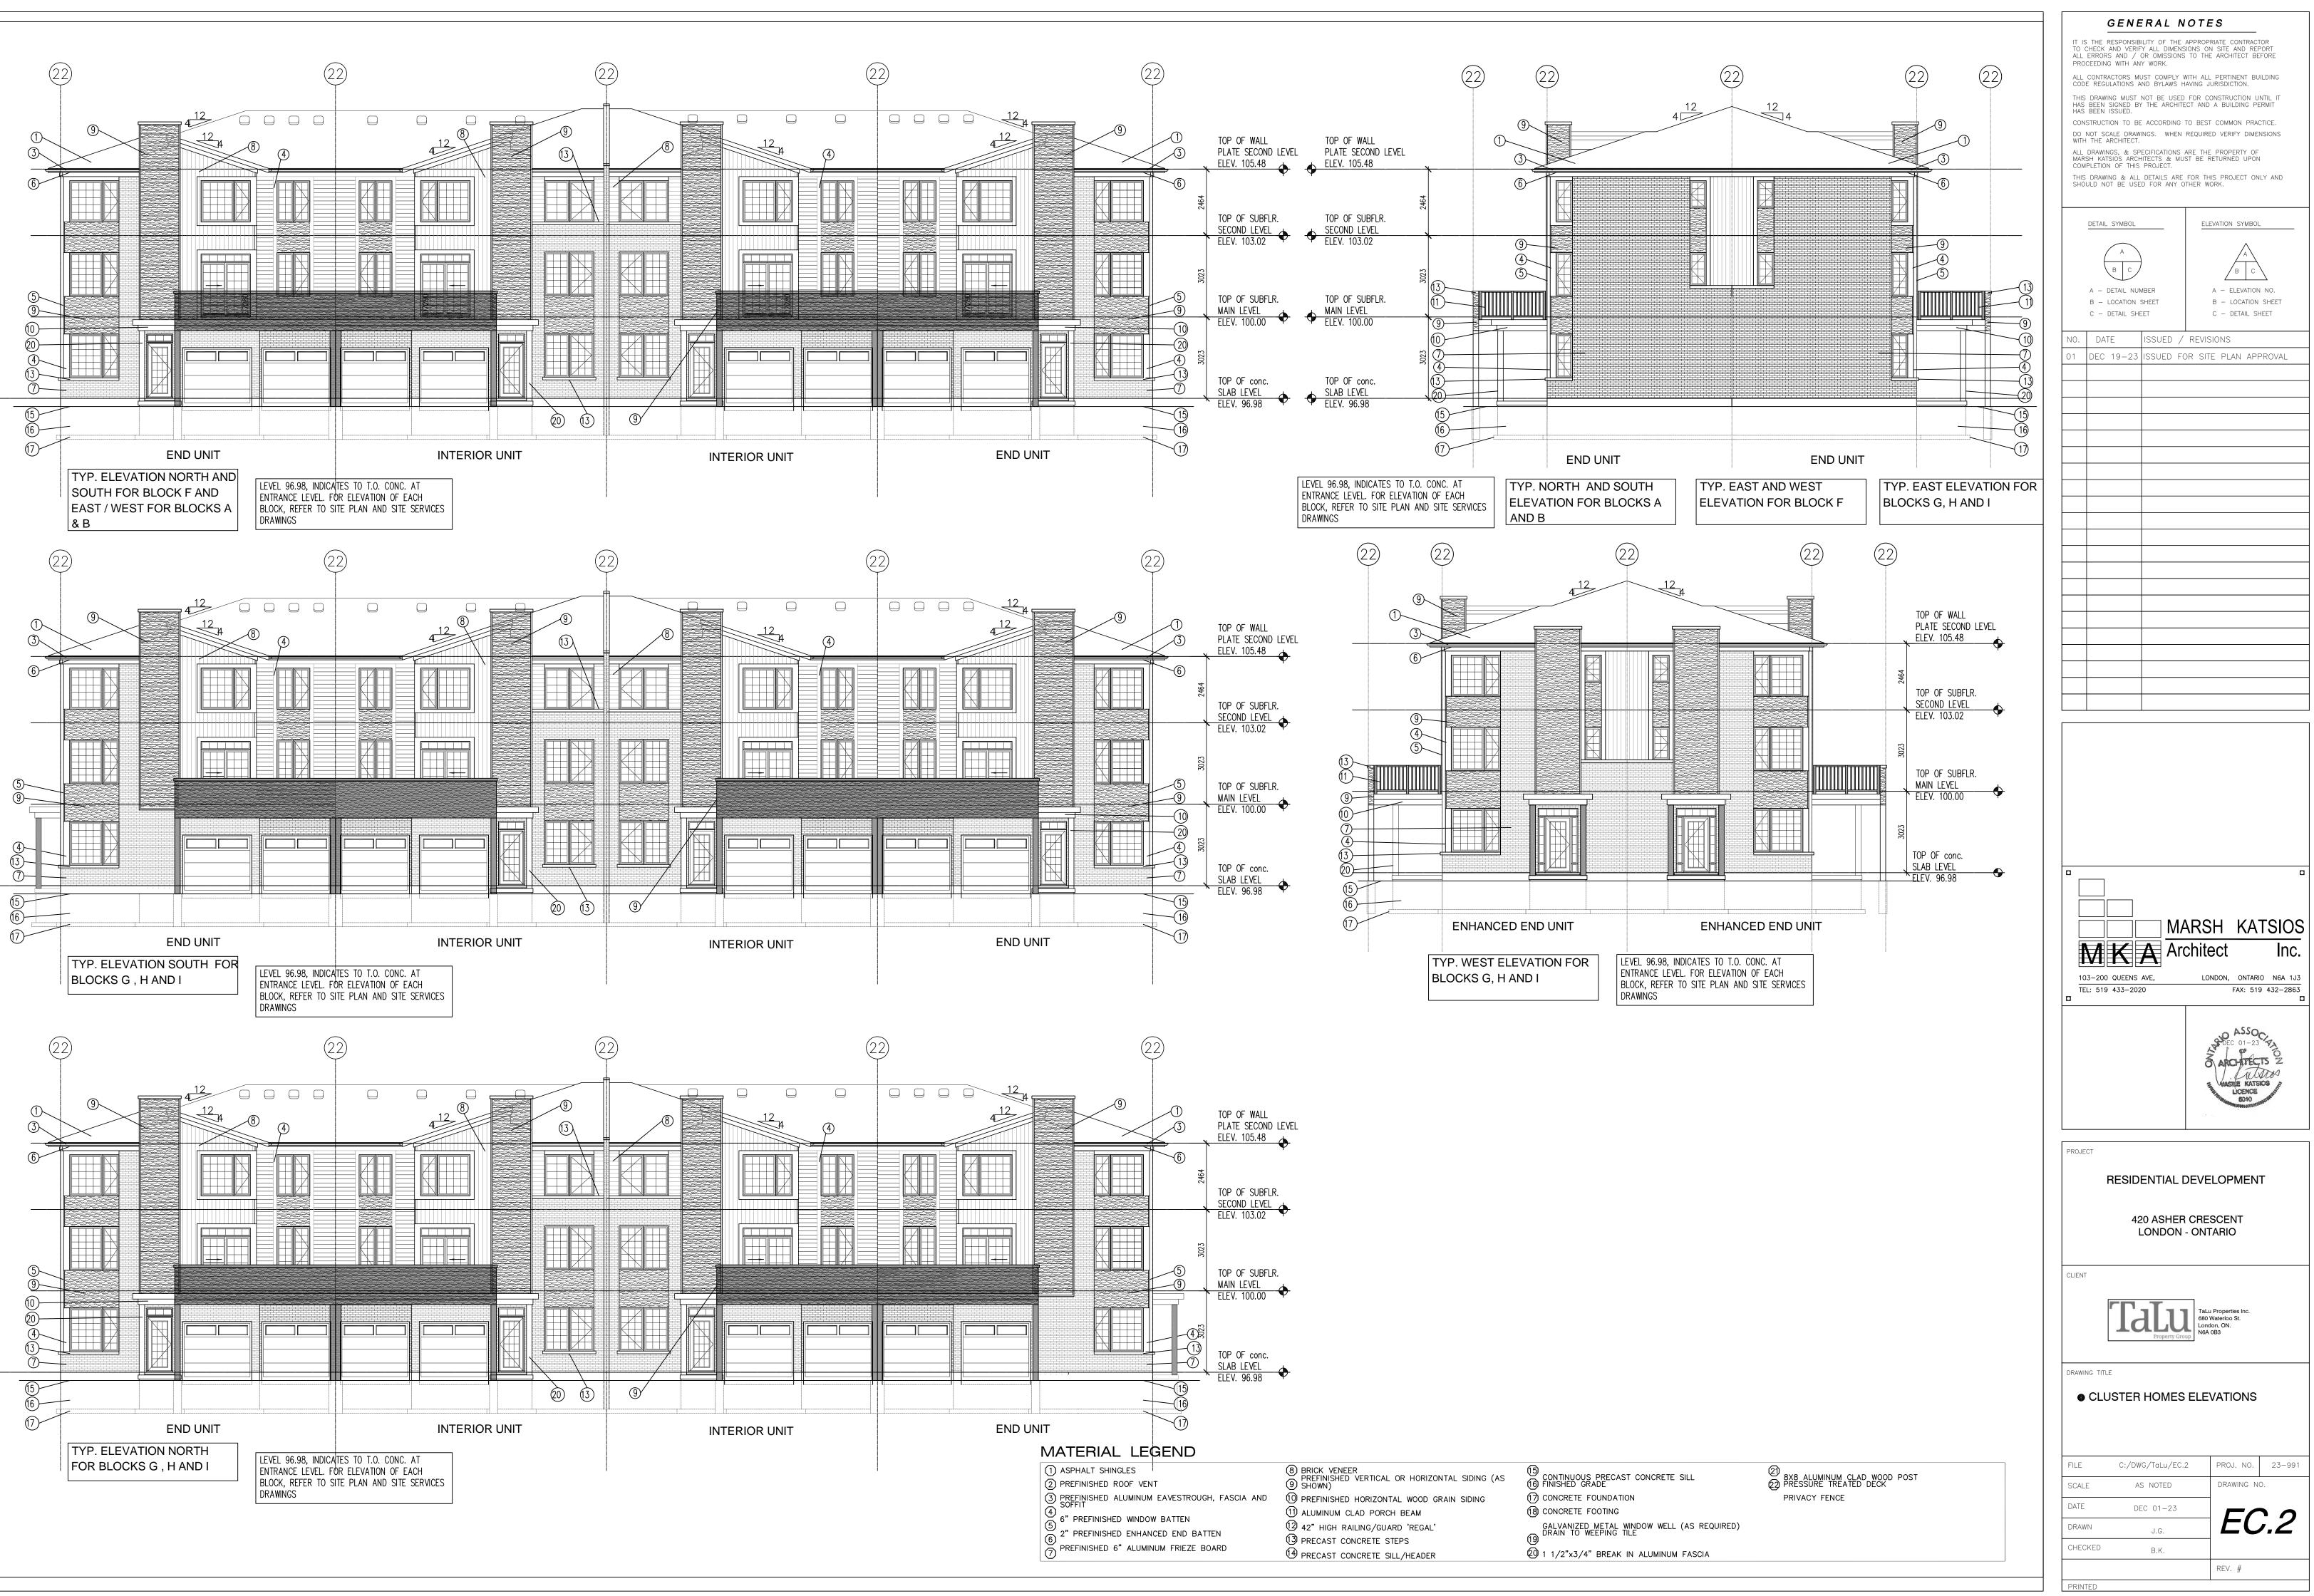




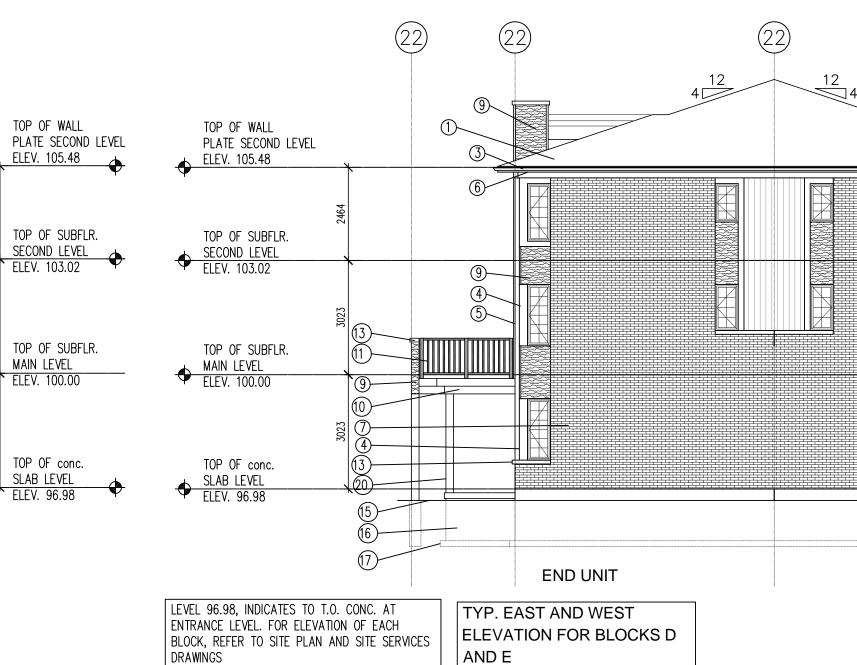

MATERIAL LEGEND

(1) ASPHALT SHINGLES (2) PREFINISHED ROOF VENT

- 3 PREFINISHED ALUMINUM EAVESTROUGH, FASCIA AND
- $\binom{4}{(5)}$ 6" PREFINISHED WINDOW BATTEN
- 2" PREFINISHED ENHANCED END BATTEN
- PREFINISHED 6" ALUMINUM FRIEZE BOARD
- BRICK VENEER
 PREFINISHED VERTICAL OR HORIZONTAL SIDING (AS
 SHOWN) 10 PREFINISHED HORIZONTAL WOOD GRAIN SIDING 1 ALUMINUM CLAD PORCH BEAM (2) 42" HIGH RAILING/GUARD 'REGAL' 🕄 PRECAST CONCRETE STEPS PRECAST CONCRETE SILL/HEADER
 - 15 CONTINUOUS PRECAST CONCRETE SILL 16 FINISHED GRADE (7) CONCRETE FOUNDATION 18 CONCRETE FOOTING GALVANIZED METAL WINDOW WELL (AS REQUIRED) DRAIN TO WEEPING TILE 1 1/2"x3/4" BREAK IN ALUMINUM FASCIA

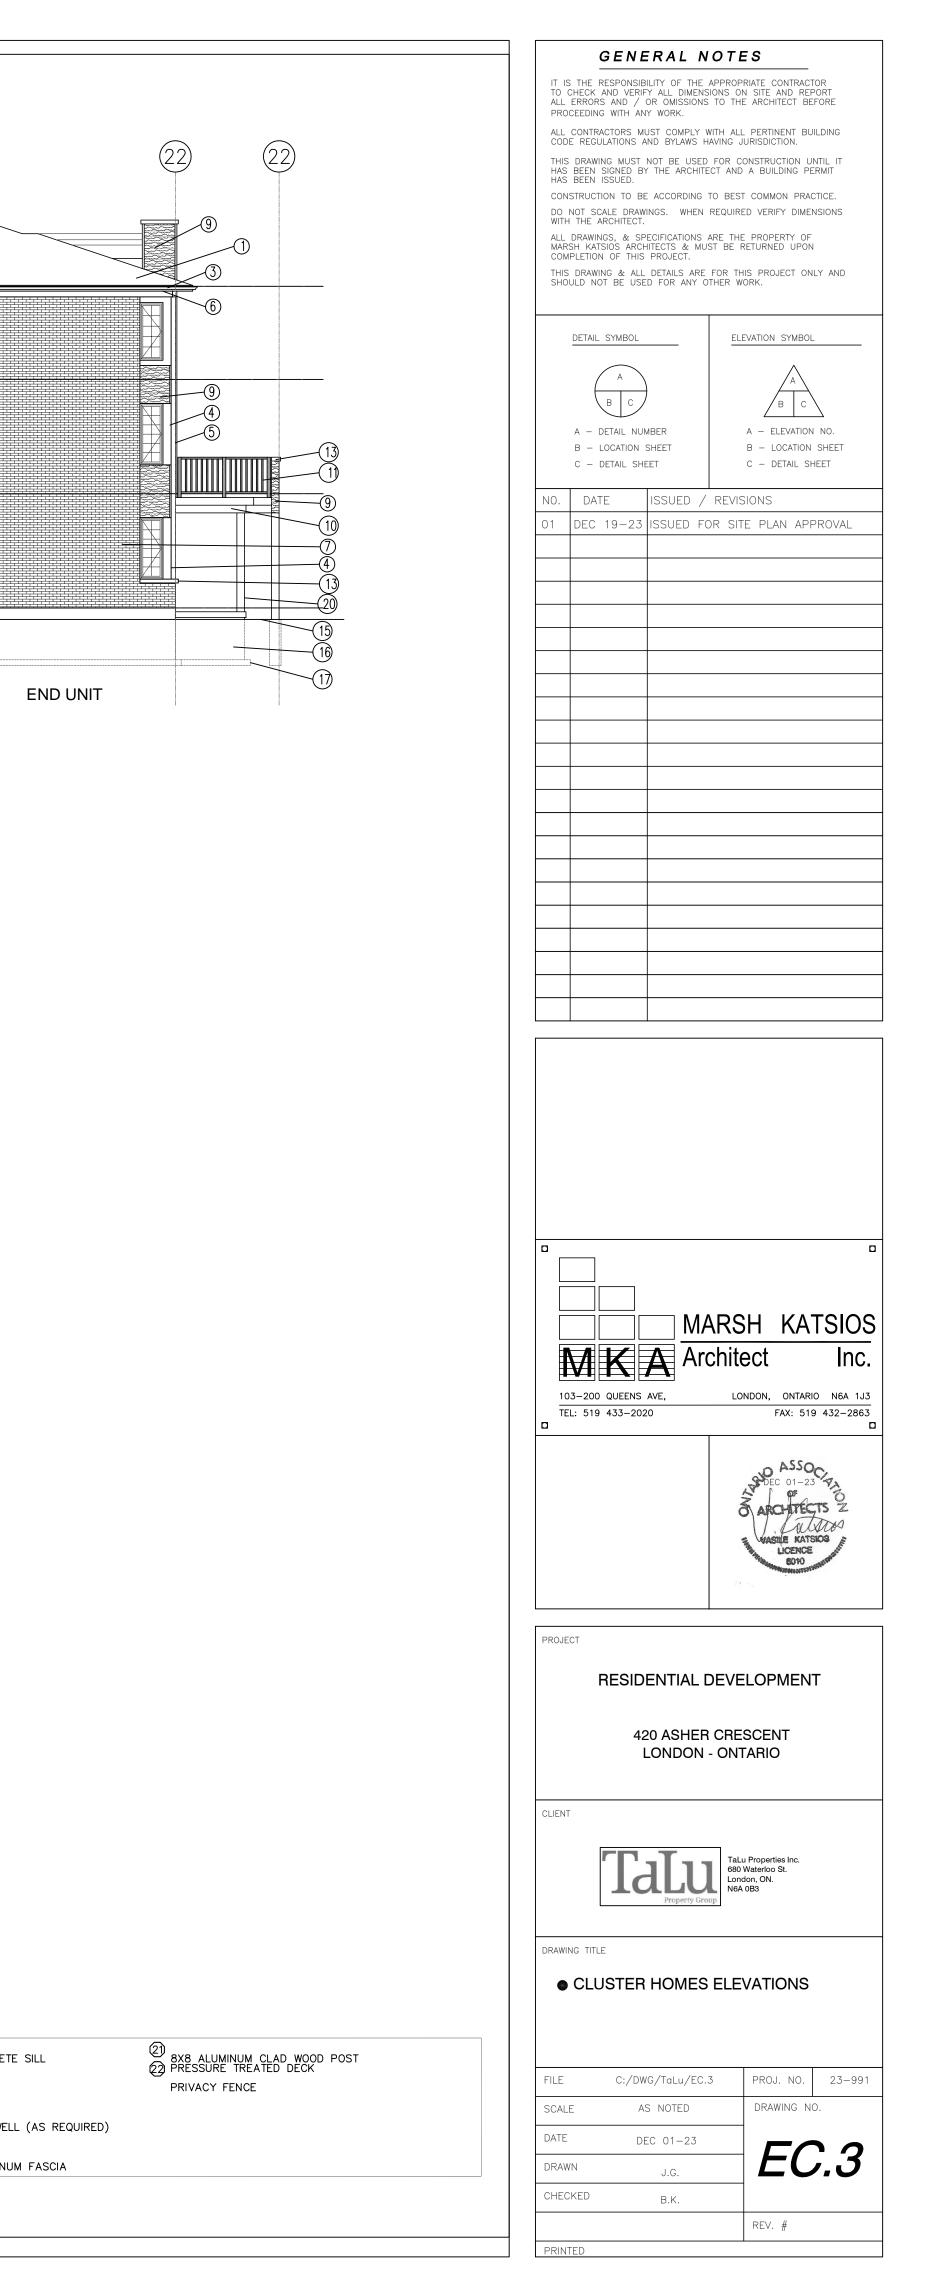

	A	(B	© D
			(W11)	MECH. ROOM BEYOND IN HARDIE BOARD FIN. TO WALL TYPE W10
ELEV. 120.580			, w10	<u>164</u>
← T/O PARAPET (TYP) ← ELEV. 119.620				
T/O CONC. TOPPING ROOF LEVEL ELEV. 119.050	230	······································		
	w10			
U/S OF CEILING ELEV. 118.571				
T/0 CONC. TOPPING 6TH LEVEL ELEV. 115.875				
U/S OF CEILING ELEV. 115.396	w10			
۲ ELEV. 113.390		(W2		
T/O CONC. TOPPING 5TH LEVEL ELEV. 112.700				
← ELEV. 112.700 ↓U/S OF CEILING ELEV. 112.221	× → √ √ 10			
ΨELEV. 112.221	2696 TYP.			
T/O CONC. TOPPING BRICK 4TH LEVEL	SHELF			
 ♥ ELEV. 109.525 ● U/S OF CEILING ● ELEV. 109.046 	w10			
ዋELEV. 109.046 ድ	41			
T/O CONC. TOPPING BRICK 3RD LEVEL	SHELF		W9 W9 W3	
U/S OF CEILING ELEV. 105.871	₩10			
ት ELEV. 105.871 ይ			(W9) (W1)	
	SHELF			
← <u>2ND LEVEL</u> – ELEV. 103.175 → U/S OF CEILING				
U/S OF CEILING ELEV. 102.696	(W9)		(W1)	
		(w2)		
T/O CONC. TOPPING FIRST LEVEL ELEV. 100.000 (282.40)	T.O.FNDTN		┙╷╴╷╴╷╴╷╴╷╴╷ ┛┛╤╪╤╋┲╤╪╤╪╶╸╲┿╤╪╴	
U/S OF CEILING	WALL			
・ ELEV. 99.521	GRADE ELEV. (280.96)			STONE VENEER AT
T/O CONC. BASEMENT LEVEL			¦ ∔¦	GROUND FLOOR LEVE (WALL TYPE W9)
Ψelev. 96.825	``			=======




	GENERAL NOTES IT IS THE RESPONSIBILITY OF THE APPROPRIATE CONTRACTOR TO CHECK AND VERIFY ALL DIMENSIONS ON SITE AND REPORT ALL ERRORS AND / OR OMISSIONS TO THE ARCHITECT BEFORE PROCEEDING WITH ANY WORK. ALL CONTRACTORS MUST COMPLY WITH ALL PERTINENT BUILDING CODE REGULATIONS AND BYLAWS HAVING JURISDICTION. THIS DRAWING MUST NOT BE USED FOR CONSTRUCTION UNTIL IT HAS BEEN SIGNED BY THE ARCHITECT AND A BUILDING PERMIT HAS BEEN ISSUED. CONSTRUCTION TO BE ACCORDING TO BEST COMMON PRACTICE. DO NOT SCALE DRAWINGS. WHEN REQUIRED VERIFY DIMENSIONS WITH THE ARCHITECT. ALL DRAWINGS, & SPECIFICATIONS ARE THE PROPERTY OF MARSH KATSIOS ARCHITECTS & MUST BE RETURNED UPON COMPLETION OF THIS PROJECT. THIS DRAWING & ALL DETAILS ARE FOR THIS PROJECT ONLY AND SHOULD NOT BE USED FOR ANY OTHER WORK.	- -
DOUBLE GLASS GON FILLED	DETAIL SYMBOL ELEVATION SYMBOL A B B C A - DETAIL NUMBER B - LOCATION SHEET B - LOCATION SHEET	
ND BALCONY DOORS EER ACCENT E W9)	C - DETAIL SHEET C - DETAIL SHEET NO. DATE ISSUED / REVISIONS 01 DEC 19-23 ISSUED FOR SITE PLAN APPROVA	
ARD PANEL E W10) GLASS BALCONY		
INEER AT FLOOR LEVEL PE W9)		
TION - BUILDING A		
	MARSH KATSI MARSH KATSI MARSH KATSI Architect I 103-200 QUEENS AVE, LONDON, ONTARIO N6 TEL: 519 433-2020 FAX: 519 432-	NC 54 1J.
	ASSO ARCHTECTS 2 WASSLE KATSIOS LICENCE SOLD	and a le
	PROJECT RESIDENTIAL DEVELOPMENT 420 ASHER CRESCENT	
	CLIENT Talu Properties Inc. 60 Waterioo St. London, ON. NeA OB3 DRAWING TITLE © BUILDING A ELEVATIONS	
N - BUILDING A	FILE C:/DWG/TaLu/EC.4 PROJ. NO. 23 SCALE AS NOTED DRAWING NO. DATE DEC 01-23 DRAWN J.G. CHECKED B.K.	<u>-99</u>
	REV. #	

	M) (L	K T/O CONCO
← T/O PARAPET (HIGH) ELEV. 120.580			w11	Феlev. 122.
T/O PARAPET (TYP) ELEV. 119.620	096			
T/O CONC. TOPPING ROOF LEVEL ELEV. 119.050 U/S OF CEUING				
U/S OF CEILING ELEV. 118.571	ST (10)	- (w2		
T/O CONC. TOPPING 6TH LEVEL ELEV. 115.875				
U/S OF CEILING ELEV. 115.396	3175	W2		
T/O CONC. TOPPING 5TH LEVEL ELEV. 112.700				
U/S OF CEILING ELEV. 112.221	2696 TYP.	W2		
T/O CONC. TOPPING 4TH LEVEL ELEV. 109.525				
U/S OF CEILING ELEV. 109.046	3175 479 811 8175			
T/O CONC. TOPPING 3RD LEVEL ELEV. 106.350				
U/S OF CEILING ELEV. 105.871	3175			
T/0 CONC. TOPPING <u>2ND LEVEL</u> ELEV. 103.175				
U/S OF CEILING ELEV. 102.696	20 (%)			
T/O CONC. TOPPING FIRST LEVEL	GRADE ELEV. 282.25			
$\begin{array}{c} \downarrow U/S \text{ OF CEILING} \\ \hline \\ \blacksquare ELEV. 99.521 \end{array}$	3175	<u>SLAB ON GRADE</u> . SEE STRUCTURE		
T/O CONC. BASEMENT_LEVEL ELEV. 96.825				
' ELEV. 90.820	L+ .		+ $ +$	



SULATED DOUBLE GLASS DW e, ARGON FILLED NDOWS AND BALCONY DOORS 'YP.)	GENERAL NOTES IT IS THE RESPONSIBILITY OF THE APPROPRIATE CONTRACTOR TO CHECK AND VERIFY ALL DIMENSIONS ON SITE AND REPORT ALL ERRORS AND / OR OMISSIONS TO THE ARCHITECT BEFORE PROCEEDING WITH ANY WORK. ALL CONTRACTORS MUST COMPLY WITH ALL PERTINENT BUILDING CODE REGULATIONS AND BYLAWS HAVING JURISDICTION. THIS DRAWING MUST NOT BE USED FOR CONSTRUCTION UNTIL IT HAS BEEN SIGNED BY THE ARCHITECT AND A BUILDING PERMIT HAS BEEN ISSUED. CONSTRUCTION TO BE ACCORDING TO BEST COMMON PRACTICE. DO NOT SCALE DRAWINGS. WHEN REQUIRED VERIFY DIMENSIONS WITH THE ARCHITECTS & MUST BE RETURNED UPON COMPLETION OF THIS PROJECT. THIS DRAWING & ALL DETAILS ARE FOR THIS PROJECT ONLY AND SHOULD NOT BE USED FOR ANY OTHER WORK.
RICK VENEER ACCENT WALL TYPE W9)	DETAIL SYMBOL ELEVATION SYMBOL A B C A - DETAIL NUMBER A B - LOCATION SHEET B C - DETAIL SHEET C
ARDIE BOARD PANEL WALL TYPE W10)	NO. DATE ISSUED / REVISIONS 01 DEC 19-23 ISSUED FOR SITE PLAN APPROVAL
1070 HT. GLASS BALCONY GUARDRAIL (TYP.)	
STONE VENEER AT GROUND FLOOR LEVEL (WALL TYPE W9)	
282.25)	
S	MARSH KATSIOS MARSH KATSIOS Architect Inc. 103-200 QUEENS AVE. 103-200 QUEENS AVE. 103-200 QUEENS AVE. 103-200 QUEENS AVE. 1000N, ONTARIO NGA 1J3 TEL: 519 433-2020 FAX: 519 432-2863 COMPANY ANOTHER TO THE AND
	RESIDENTIAL DEVELOPMENT 420 ASHER CRESCENT LONDON - ONTARIO
	CLIENT Talu Properties Inc. 80 Waterioo St. Condon, ON. No OB DRAWING TITLE BUILDING A ELEVATIONS
TION - BUILDING A	FILEC:/DWG/TaLu/EC.5PROJ. NO.23-991SCALEAS NOTEDDRAWING NO.DATEDEC 01-23DRAWNJ.G.DRAWNJ.G.EC.55CHECKEDB.K.REV. #PRINTEDPRINTED

ф T/O PARAPET (HIGH)	A	B (W11)	C MECH. ROOM BEYON IN HARDIE BOARD FI TO WALL TYPE W10
← T/O PARAPET (HIGH) ← ELEV. 120.580			16
T/O PARAPET (TYP) ELEV. 119.620 T/O CONC. TOPPING ROOF LEVEL ELEV. 119.050			
U/S OF CEILING ELEV. 118.571	w10	W2	(W1)
T/O CONC. TOPPING 0 TH LEVEL ELEV. 115.875 U/S OF CEILING ELEV. 115.396			
3175		W2 W1	(W1)
T/O CONC. TOPPING 5TH LEVEL ELEV. 112.700 U/S OF CEILING ELEV. 112.221			
T/O CONC. TOPPING BRICK SHE 4TH LEVEL ELEV. 109.525			
U/S OF CEILING			
T/O CONC. TOPPING BRICK SHE			
€LEV. 105.871			
T/O CONC. TOPPING 2ND LEVEL ELEV. 103.175 U/S OF CEILING			
T/O CONC. TOPPING	(we)		
	FNDTN WALL DE ELEV. 2.66)		ew
T/O CONC. BASEMENT LEVEL		<u>+</u>	STONE VENER GROUND FLO (WALL TYPE
	ч — — —		

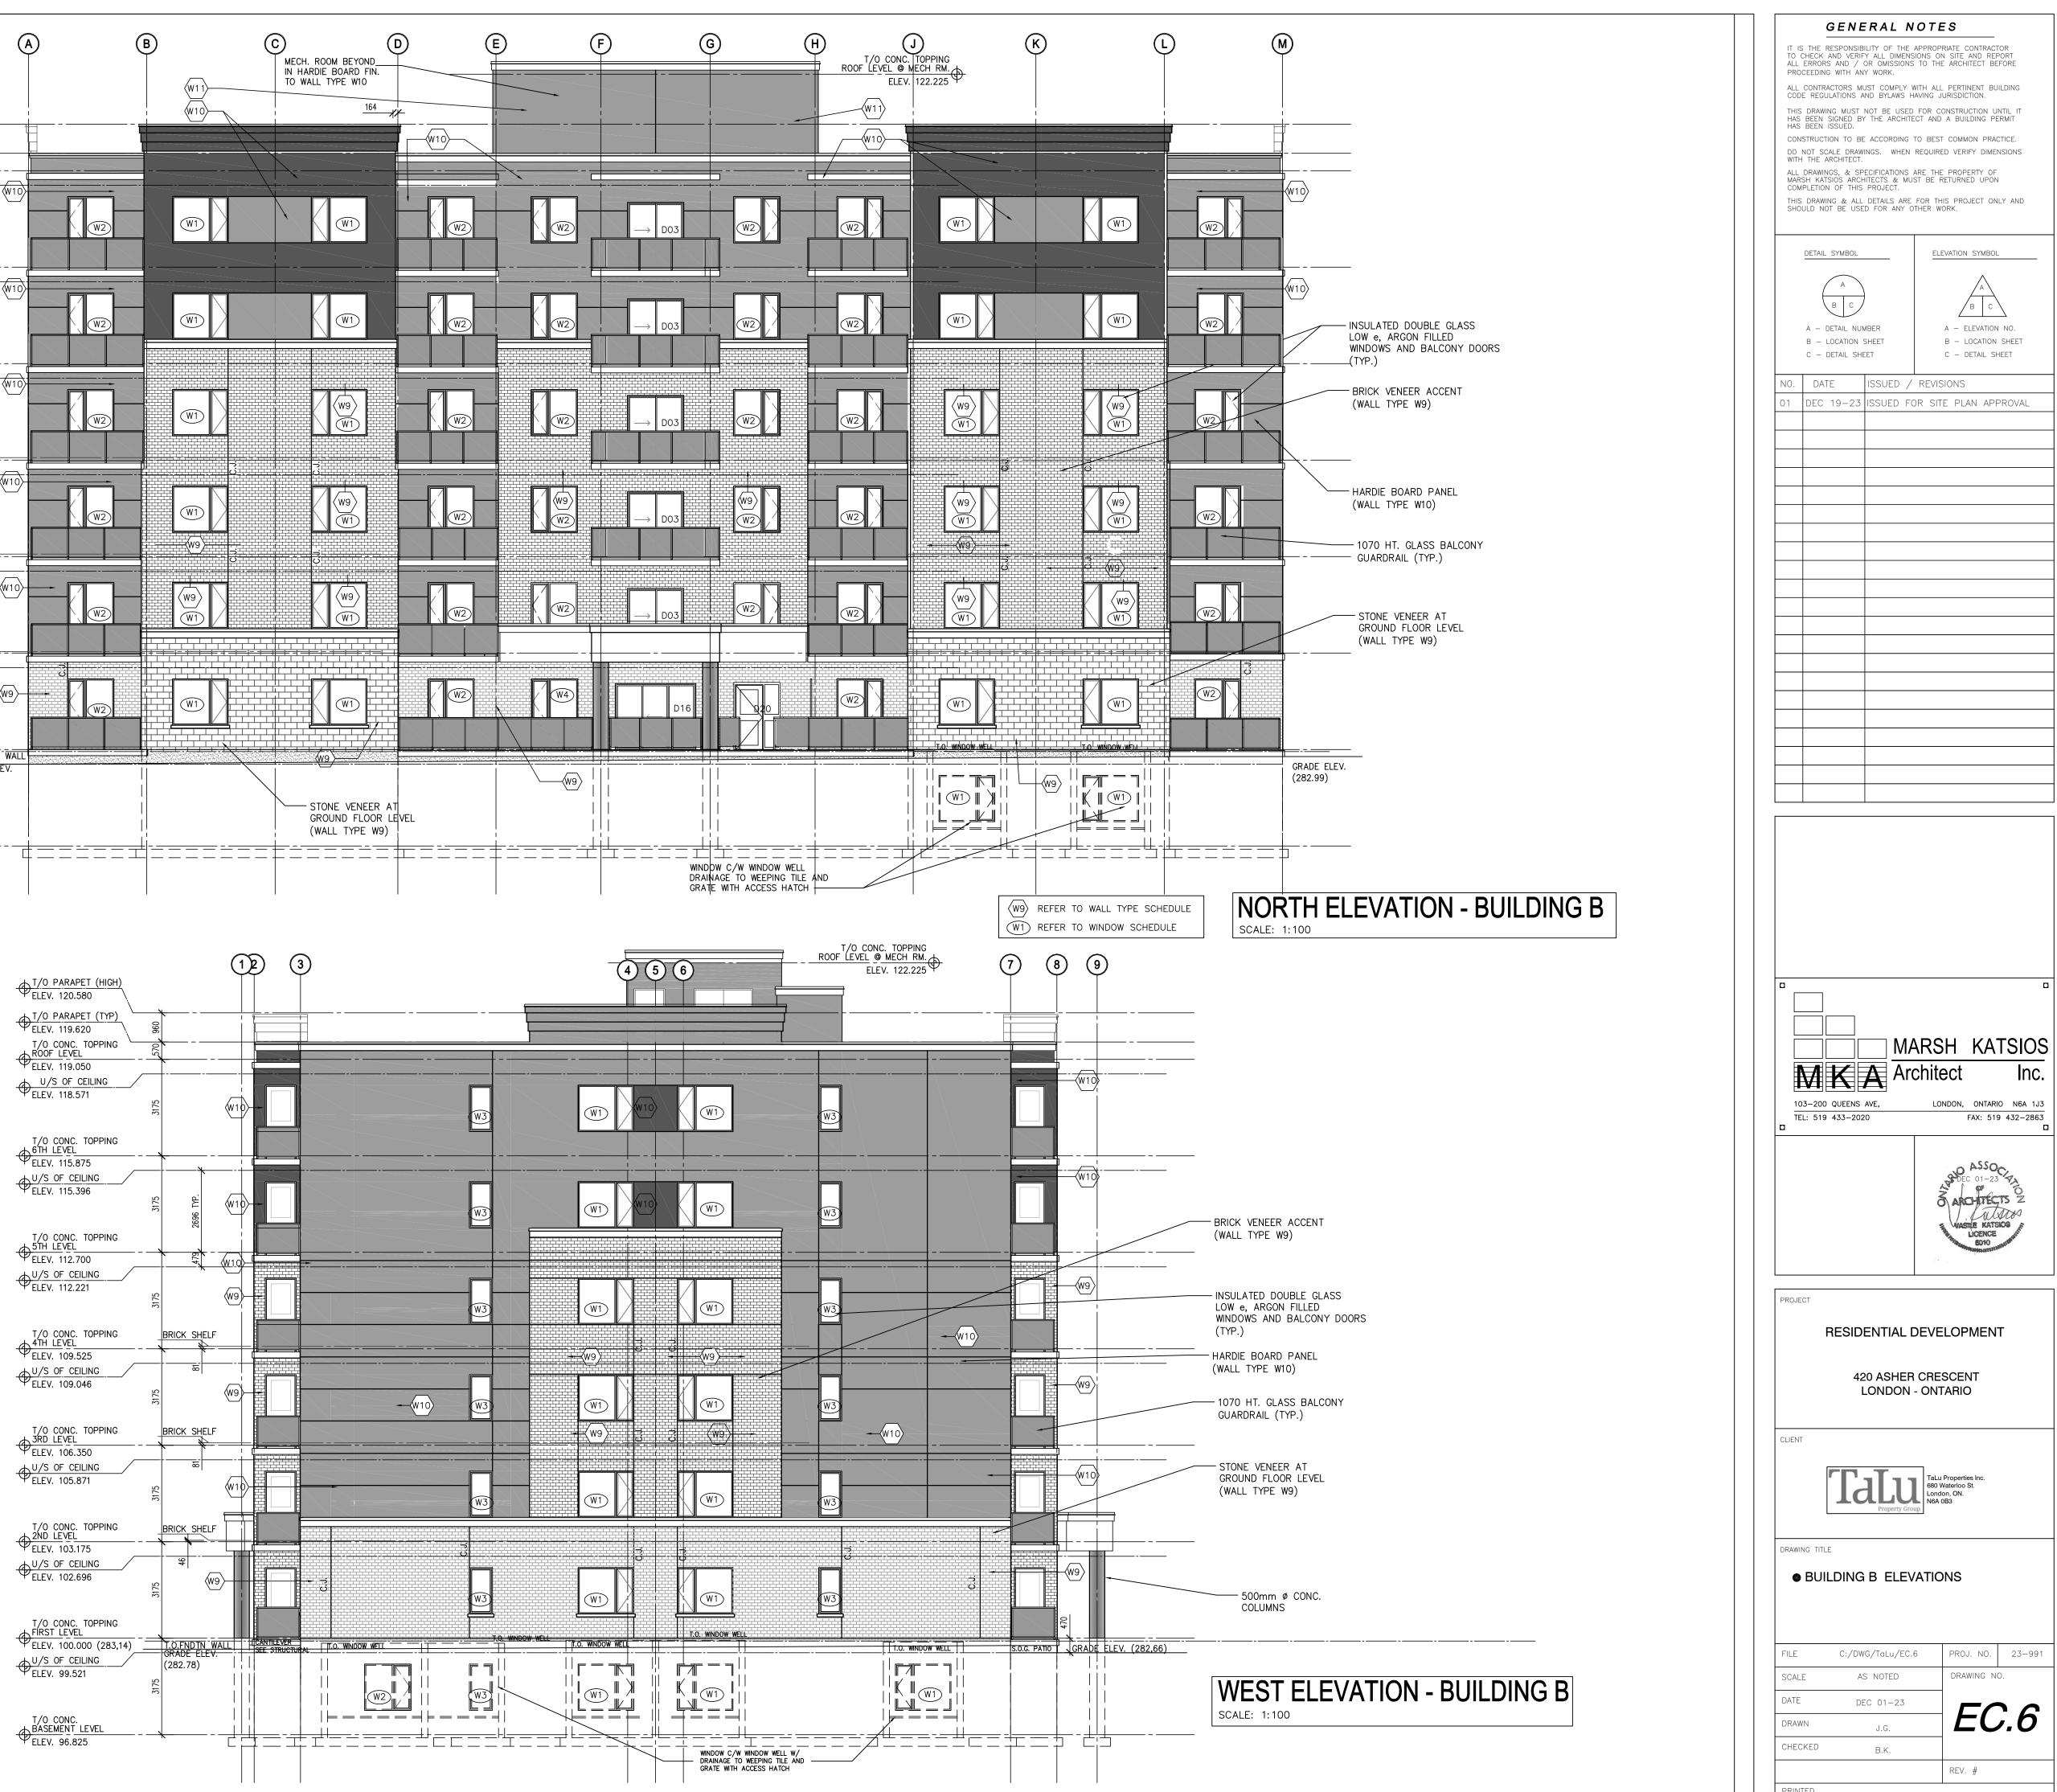



		(9) (8) (7)
T/O PARAPET (HIGH) ELEV. 120.580			
⊕ T/O PARAPET (TYP) €LEV. 119.620	096		
T/O CONC. TOPPING ROOF LEVEL ELEV. 119.050	220		
U/S OF CEILING ELEV. 118.571	3175	W10	
T/O CONC. TOPPING 6TH LEVEL ELEV. 115.875			
U/S OF CEILING ELEV. 115.396	75	(W10)-	
T/O CONC. TOPPING 5TH LEVEL ELEV. 112.700	· 3175		
€LEV. 112.700 ↓U/S OF CEILING €LEV. 112.230			
	3175		
T/O CONC. TOPPING 4TH LEVEL ELEV. 109.525	BRICK SHELF		
U/S OF CEILING ELEV. 109.046	3175 	(W9) - D09	
T/O CONC. TOPPING 3RD LEVEL ELEV. 106.350	BRICK SHELF		
U/S OF CEILING ELEV. 105.871	3175	W10	
T/O CONC. TOPPING			
Ψ ELEV. 103.175 U/S OF CEILING ELEV. 102.696	3175	W9 D09	
T/O CONC. TOPPING			
€LEV. 100.000 (283,14) ↓U/S OF CEILING ELEV. 99.521	GRADE <u>ELEV. (28</u>	2.99) SLAB ON GRAT SE STRUCTUR	
T/O CONC. BASEMENT LEVEL ELEV. 96.825			
· LLLV. 30.023			<u>+</u>


	GENERAL NOTES IT IS THE RESPONSIBILITY OF THE APPROPRIATE CONTRACTOR TO CHECK AND VERIFY ALL DIMENSIONS ON SITE AND REPORT ALL ERRORS AND / OR OMISSIONS TO THE ARCHITECT BEFORE PROCEEDING WITH ANY WORK.
INSULATED DOUBLE GLASS LOW e, ARGON FILLED WINDOWS AND BALCONY DOORS (TYP.)	ALL CONTRACTORS MUST COMPLY WITH ALL PERTINENT BUILDING CODE REGULATIONS AND BYLAWS HAVING JURISDICTION. THIS DRAWING MUST NOT BE USED FOR CONSTRUCTION UNTIL IT HAS BEEN SIGNED BY THE ARCHITECT AND A BUILDING PERMIT HAS BEEN ISSUED. CONSTRUCTION TO BE ACCORDING TO BEST COMMON PRACTICE. DO NOT SCALE DRAWINGS. WHEN REQUIRED VERIFY DIMENSIONS WITH THE ARCHITECT. ALL DRAWINGS, & SPECIFICATIONS ARE THE PROPERTY OF MARSH KATSIOS ARCHITECTS & MUST BE RETURNED UPON COMPLETION OF THIS PROJECT. THIS DRAWING & ALL DETAILS ARE FOR THIS PROJECT ONLY AND SHOULD NOT BE USED FOR ANY OTHER WORK.
	DETAIL SYMBOL ELEVATION SYMBOL A B C A DETAIL NUMBER A B C A B C C B C C B C C B C C B C C C DETAIL SHEET C C DETAIL SHEET C C DETAIL SHEET C
HARDIE BOARD PANEL (WALL TYPE W10) 	NO. DATE ISSUED / REVISIONS 01 DEC 19-23 ISSUED FOR SITE PLAN APPROVAL
UARDRAIL (TYP.)	
STONE VENEER AT GROUND FLOOR LEVEL (WALL TYPE W9)	
 EV. (282.78)	
TION - BUILDING B	
	MARSH KATSIOS MARSH KATSIOS Architect Inc. 103-200 QUEENS AVE, LONDON, ONTARIO N6A 1J3 TEL: 519 433-2020 FAX: 519 432-2863
S	ASSO DEC 01-23 7 ARCHTECTS Z MASSILE KATSIOS LICENCE SO10
DOORS	PROJECT RESIDENTIAL DEVELOPMENT 420 ASHER CRESCENT LONDON - ONTARIO
ΙΥ	CLIENT Talu Properties Inc. 680 Waterioo St. London, ON. N6A 0B3
	BUILDING B ELEVATIONS
VATION - BUILDING B	FILE C:/DWG/TaLu/EC.7 PROJ. NO. 23-991 SCALE AS NOTED DRAWING NO. DATE DEC 01-23 DRAWING NO. DRAWN J.G. EC.7 CHECKED B.K. REV. #





INSULATED DOUBLE GLASS LOW e, ARGON FILLED WINDOWS AND BALCONY DOORS - BRICK VENEER ACCENT HARDIE BOARD PANEL - 1070 HT. GLASS BALCONY STONE VENEER AT GROUND FLOOR LEVEL

SOUTH ELEVATION - BUILDING C

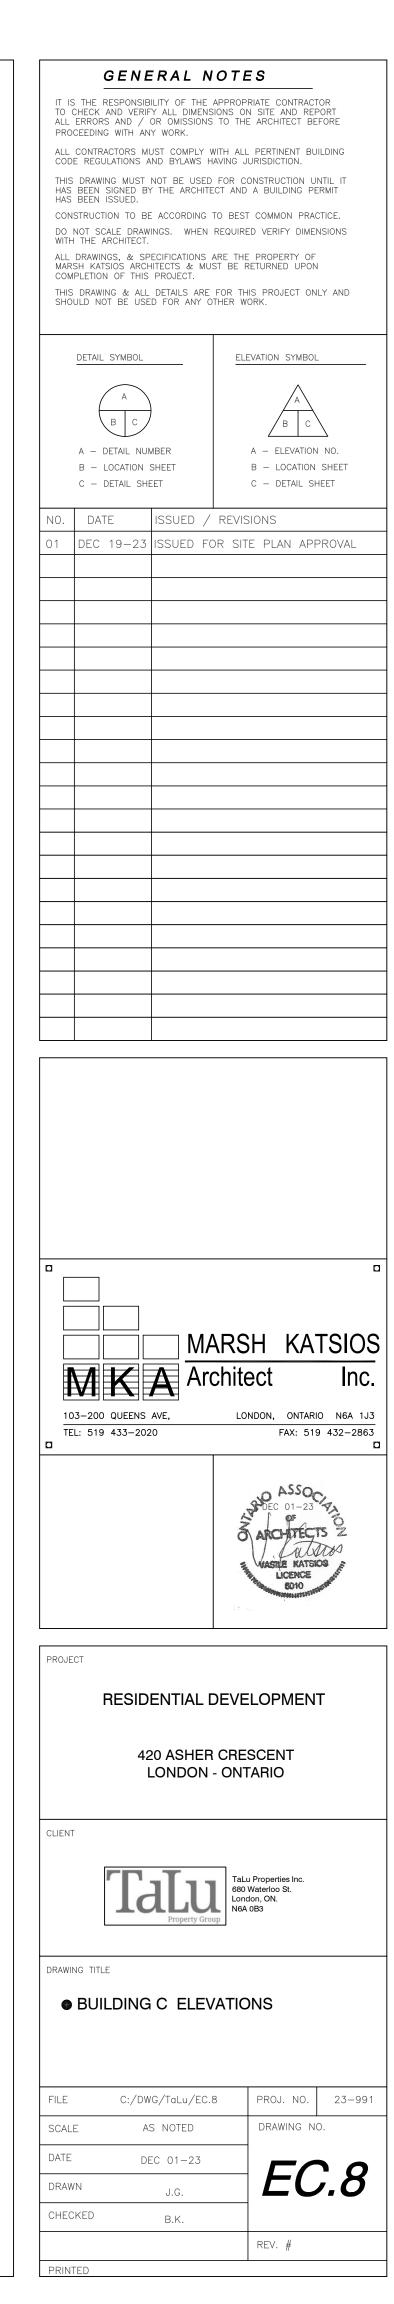

• T/O PARAPET (HIGH) ELEV. 117.525			В	W11 W10	C MECH IN H/ TO W	I. ROOM BEYOND ARDIE BOARD FIN ALL TYPE W10)
T/O PARAPET (TYP) ELEV. 116.565 T/O CONC. TOPPING ROOF LEVEL AT EDGE 115.995	570 960								
U/S OF CEILING ELEV. 115.405	3175	- W10		(W1)		(W1)			
T/O CONC. TOPPING 5TH LEVEL ELEV. 112.700 U/S OF CEILING ELEV. 112.230	3175			(W1)		(W1)			
T/O CONC. TOPPING 4TH LEVEL ELEV. 109.525 U/S OF CEILING ELEV. 109.055	3175	·							
T/O CONC. TOPPING 3RD LEVEL ELEV. 106.350 U/S OF CEILING ELEV. 105.880	« 								
T/O CONC. TOPPING 2ND LEVEL ELEV. 103.175	3175								
U/S OF CEILING ELEV. 102.75	3175	 (w9)							
T/O CONC. TOPPING	<u></u>								
<pre></pre>	3175	T.O.FNDTN-WALL	 - + 1 			STONE VENEE GROUND FLOC (WALL TYPE V	R AT DR LEVEL	9 <u>99951288499572288997</u> 55	
BASEMENT LEVEL – – – – – – – – – – – – – – – – – – –		Ļ [- 	 	=====		====			



NORTH ELEVATION - BUILDING C SCALE: 1:100

	GENERAL NOTES					
TO ALL	IT IS THE RESPONSIBILITY OF THE APPROPRIATE CONTRACTOR TO CHECK AND VERIFY ALL DIMENSIONS ON SITE AND REPORT ALL ERRORS AND / OR OMISSIONS TO THE ARCHITECT BEFORE PROCEEDING WITH ANY WORK.					
ALL	CONTRACTORS MUST COMPLY N E REGULATIONS AND BYLAWS H	WITH ALL IAVING J	PERTINENT BUILDING URISDICTION.			
HAS	5 DRAWING MUST NOT BE USED 5 BEEN SIGNED BY THE ARCHITE 5 BEEN ISSUED.					
DO	ISTRUCTION TO BE ACCORDING NOT SCALE DRAWINGS. WHEN H THE ARCHITECT.					
ALL MAR	DRAWINGS, & SPECIFICATIONS SH KATSIOS ARCHITECTS & MU IPLETION OF THIS PROJECT.					
THIS	5 DRAWING & ALL DETAILS ARE SULD NOT BE USED FOR ANY C					
	DETAIL SYMBOL	ELE	EVATION SYMBOL			
			A			
	A - DETAIL NUMBER A - ELEVATION NO.					
	B – LOCATION SHEET C – DETAIL SHEET		B – LOCATION SHEET C – DETAIL SHEET			
NO.	DATE ISSUED /	REVIS	SIONS			
01	DEC 19-23 ISSUED FO	OR SIT	E PLAN APPROVAL			
	MARSH KATSIOS MARSH KATSIOS Architect Inc.					
PROJE	PROJECT RESIDENTIAL DEVELOPMENT 420 ASHER CRESCENT LONDON - ONTARIO					
CLIEN	CLIENT Talu Properties Inc. 80 Waterloo St. London, ON. N6A OB3					
	BUILDING C ELEVATIONS					
FILE	, , , ,	9	PROJ. NO. 23-991			
SCAL DATE			DRAWING NO.			
DRAV	DEC 01-23		EC.9			
CHEC	CKED B.K.					